DOOR TYPE

CLOUDED)

WINDOW TYPE

REVISION (ONLY MOST

RECENT REVISION SHOWN

CENTER LINE

EXHAUST FAN

SMOKE DETECTOR

CARBON MONOXIDE DETECTOR

EF

•co

SD

1. THE ALTERATION IMPROVES THE ENERGY EFFICIENCY OF THE BUILDING.

S \simeq 2

REGISTERED LARCHITECT ' AMES PATRICK ROMANO STATE OF WASHINGTON

stamp File Name: VAND A0.1 general info Plot Date: **3/15/24** Project ID: **VAND** Drawn: **EV**

Checked: JR mark date issue description 1/26/21 BUILDING PERMIT 1 3/15/24 PERMIT REVISION II

Issue For: PERMIT REVISION II

sheet info


GENERAL PROJECT INFO

0 1

if scale is not 1", this drawing has been enlarged or reduced sheet title


A0.1

sheet number

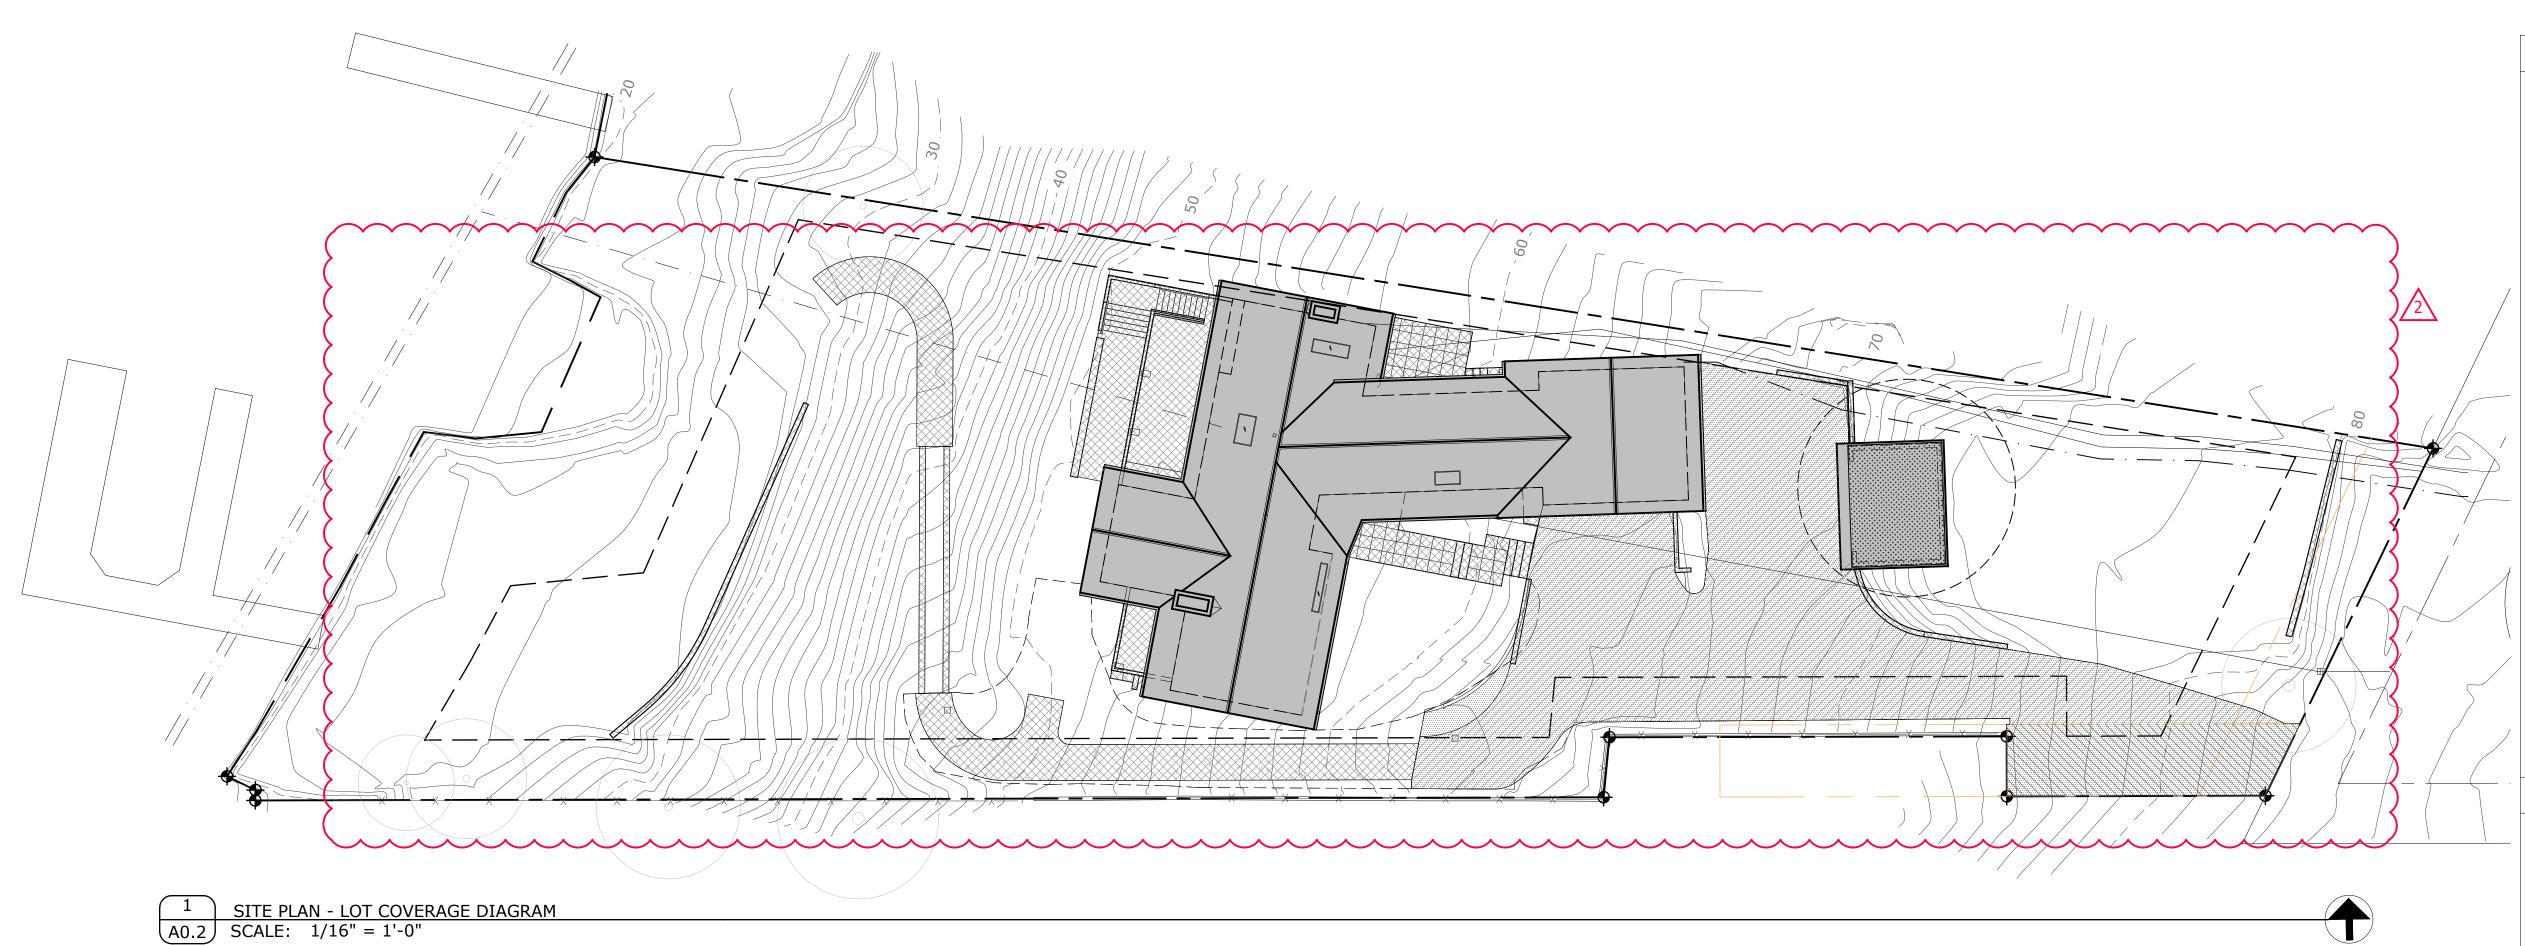

EXISTING BASEMENT

(E) AREA BOUND BY EXTERIOR FACE = 1,596 SF

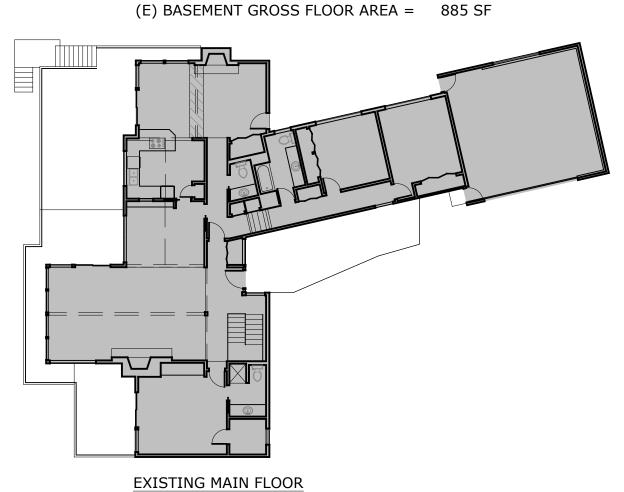


AREA EXCLUDED PER APPENDIX B = (711) SF


(E) AREA BOUND BY EXTERIOR FACE = 2,783 SF 150% AREA FOR 12'-16'CLNG = 42 SF

(E) MAIN FLOOR GROSS FLOOR AREA = 2,825 SF

GROSS FLOOR AREA CALCULATIONS

A0.2 SCALE: 1/16" = 1'-0"

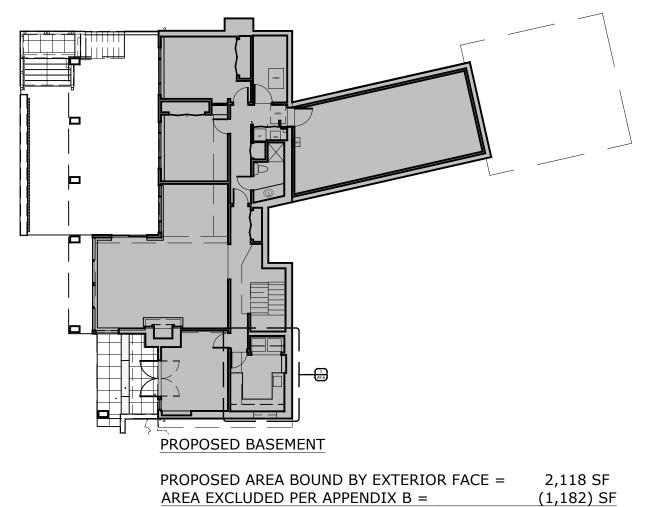

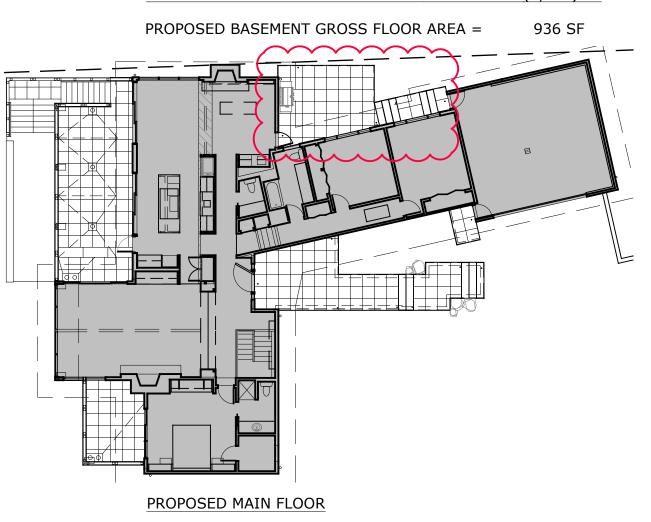

PROPOSED MAIN FLOOR

PROPOSED AREA BOUND BY EXTERIOR FACE = 2,808 SF

150% AREA FOR 12'-16'CLNG = 54 SF

PROPOSED MAIN FLOOR GROSS FLOOR AREA = 2,862 SF

BASEMENT STRUCTURAL WALL ALTERATION CALC

LF OF EXISTING EXTERIOR WALL = 202.72 LF
LF OF EXTERIOR WALL BEING ALTERED = 0.00 LF
% OF BASEMENT WALL ALTERATION = 0.00%


MAIN FLOOR STRUCTURAL WALL ALTERATION CALC

LF OF EXISTING EXTERIOR WALL = 336.41 LF

LF OF EXTERIOR WALL BEING ALTERED = 102.33 LF

% OF MAIN FLOOR WALL ALTERATION = 30.4%

3 STRUCTURAL WALL ALTERATION CALCULATION
A0.2 SCALE: 1/16" = 1'-0"

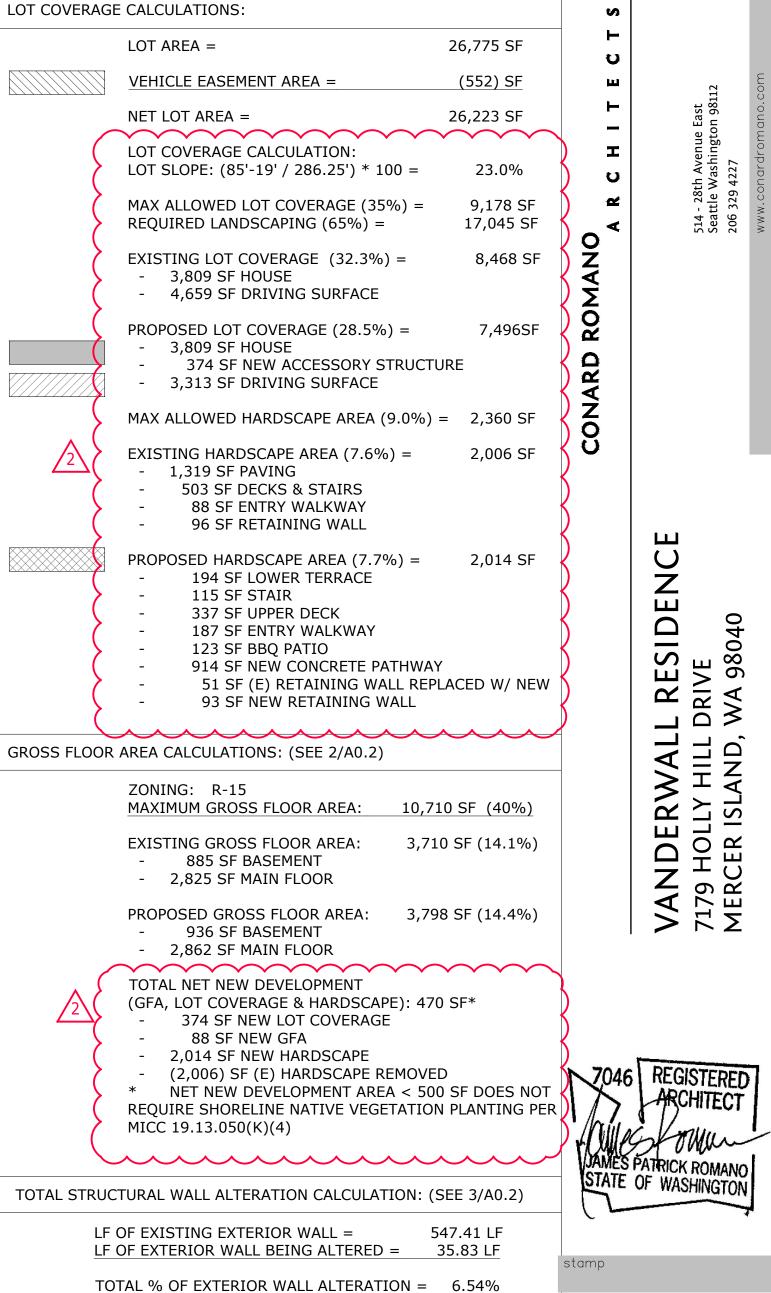

1/26/21 BUILDING PERMIT
8/31/21 CD SET
4/20/22 PERMIT REVISION
9 PERMIT REVISION II

Issue For: PERMIT REVISION II

sheet info

mark date issue description

∮ile Name: **VAND A0.1 general info**


Plot Date: 3/15/24 Project ID: VAND

Checked: JR

LAND USE CALCS

A0.2

sheet number

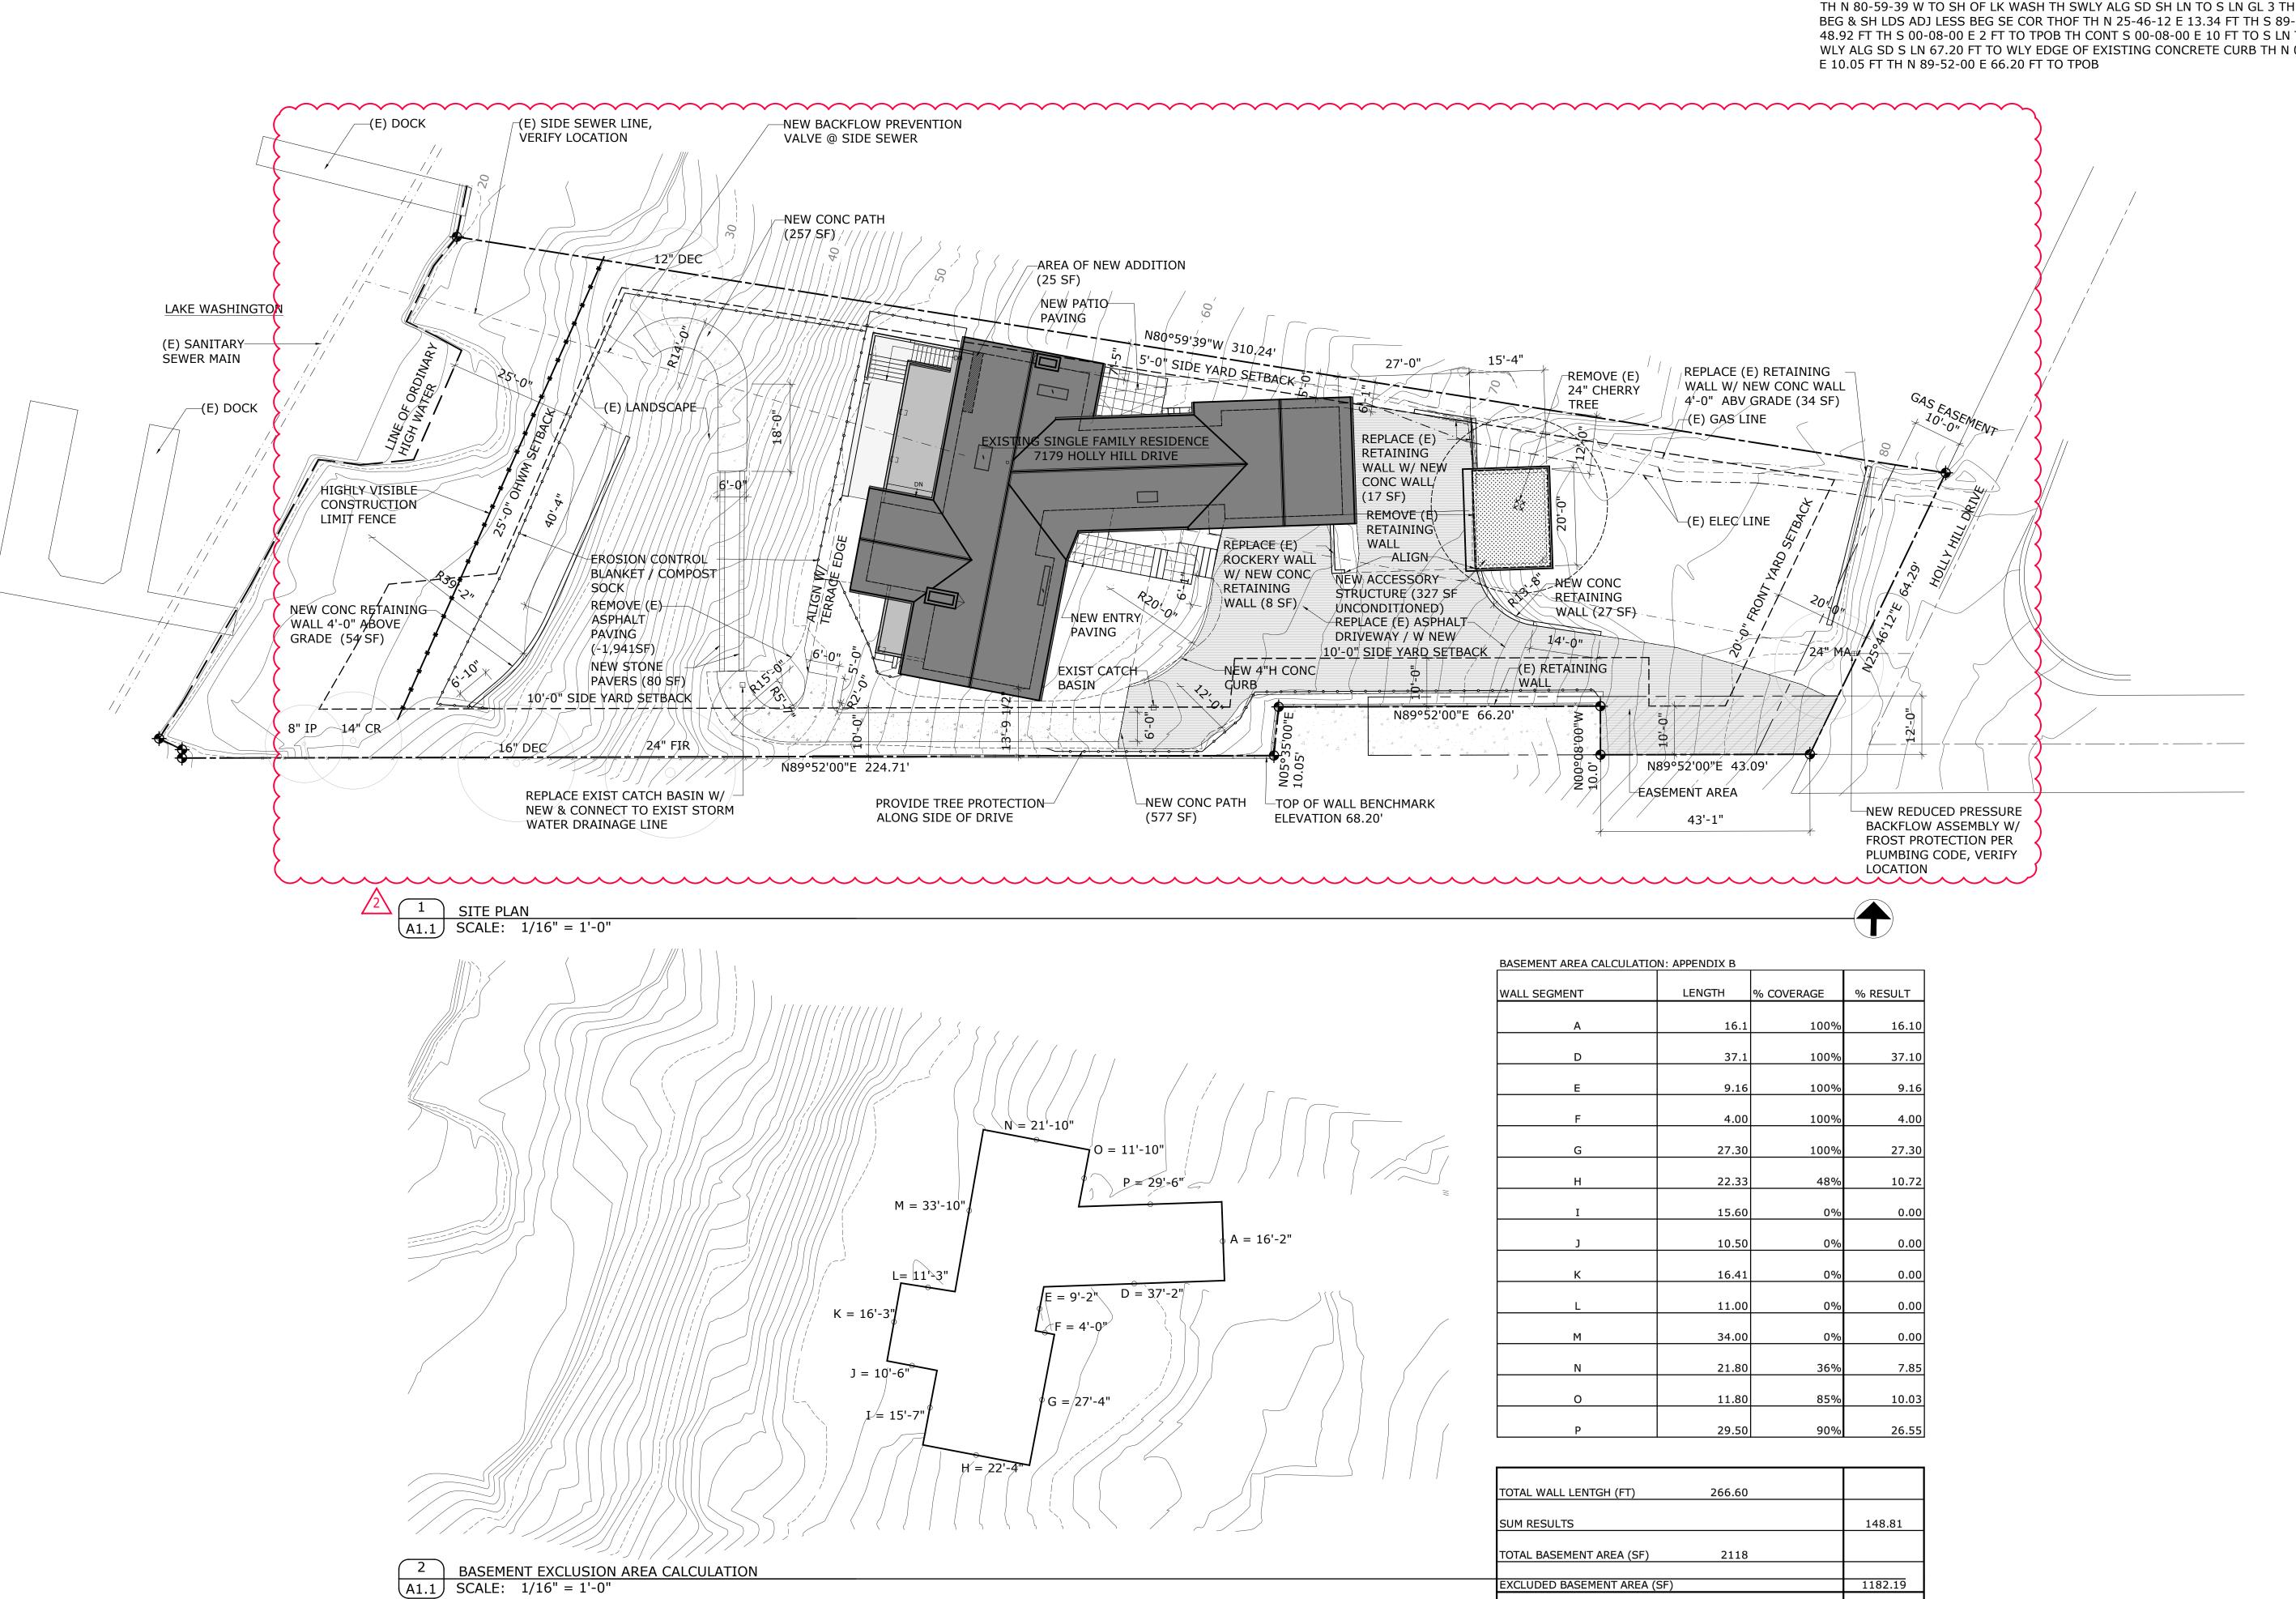

BASEMENT GROSS FLOOR AREA (SF)

935.81

SITE INFORMATION

ASSESSOR'S PARCEL NUMBER: 252404-9049

LEGAL DESCRIPTION: POR GL 3 BEG S 89-52-00 W 3805 FT OF E 1/4 COR OF SEC TH N 25-46-12 E 64.29 FT TH N 80-59-39 W TO SH OF LK WASH TH SWLY ALG SD SH LN TO S LN GL 3 TH ELY TO BEG & SH LDS ADJ LESS BEG SE COR THOF TH N 25-46-12 E 13.34 FT TH S 89-52-00 W 48.92 FT TH S 00-08-00 E 2 FT TO TPOB TH CONT S 00-08-00 E 10 FT TO S LN THOF TH WLY ALG SD S LN 67.20 FT TO WLY EDGE OF EXISTING CONCRETE CURB TH N 05-35-00

RESIDE VANDERWALL I 7179 HOLLY HILL DR MERCER ISLAND, W.



File Name: VAND A1.0 site plan Plot Date: **3/15/24** Project ID: VAND

Drawn: **EV** Checked: JR mark date issue description

1/26/21 BUILDING PERMIT 8/31/21 CD SET 12/1/23 PERMIT REVISION 3/15/24 PERMIT REVISION II


Issue For: PERMIT REVISION II


ARCH SITE **PLAN**

sheet info

0 1 if scale is not 1", this drawing has been enlarged or reduced sheet title

sheet number

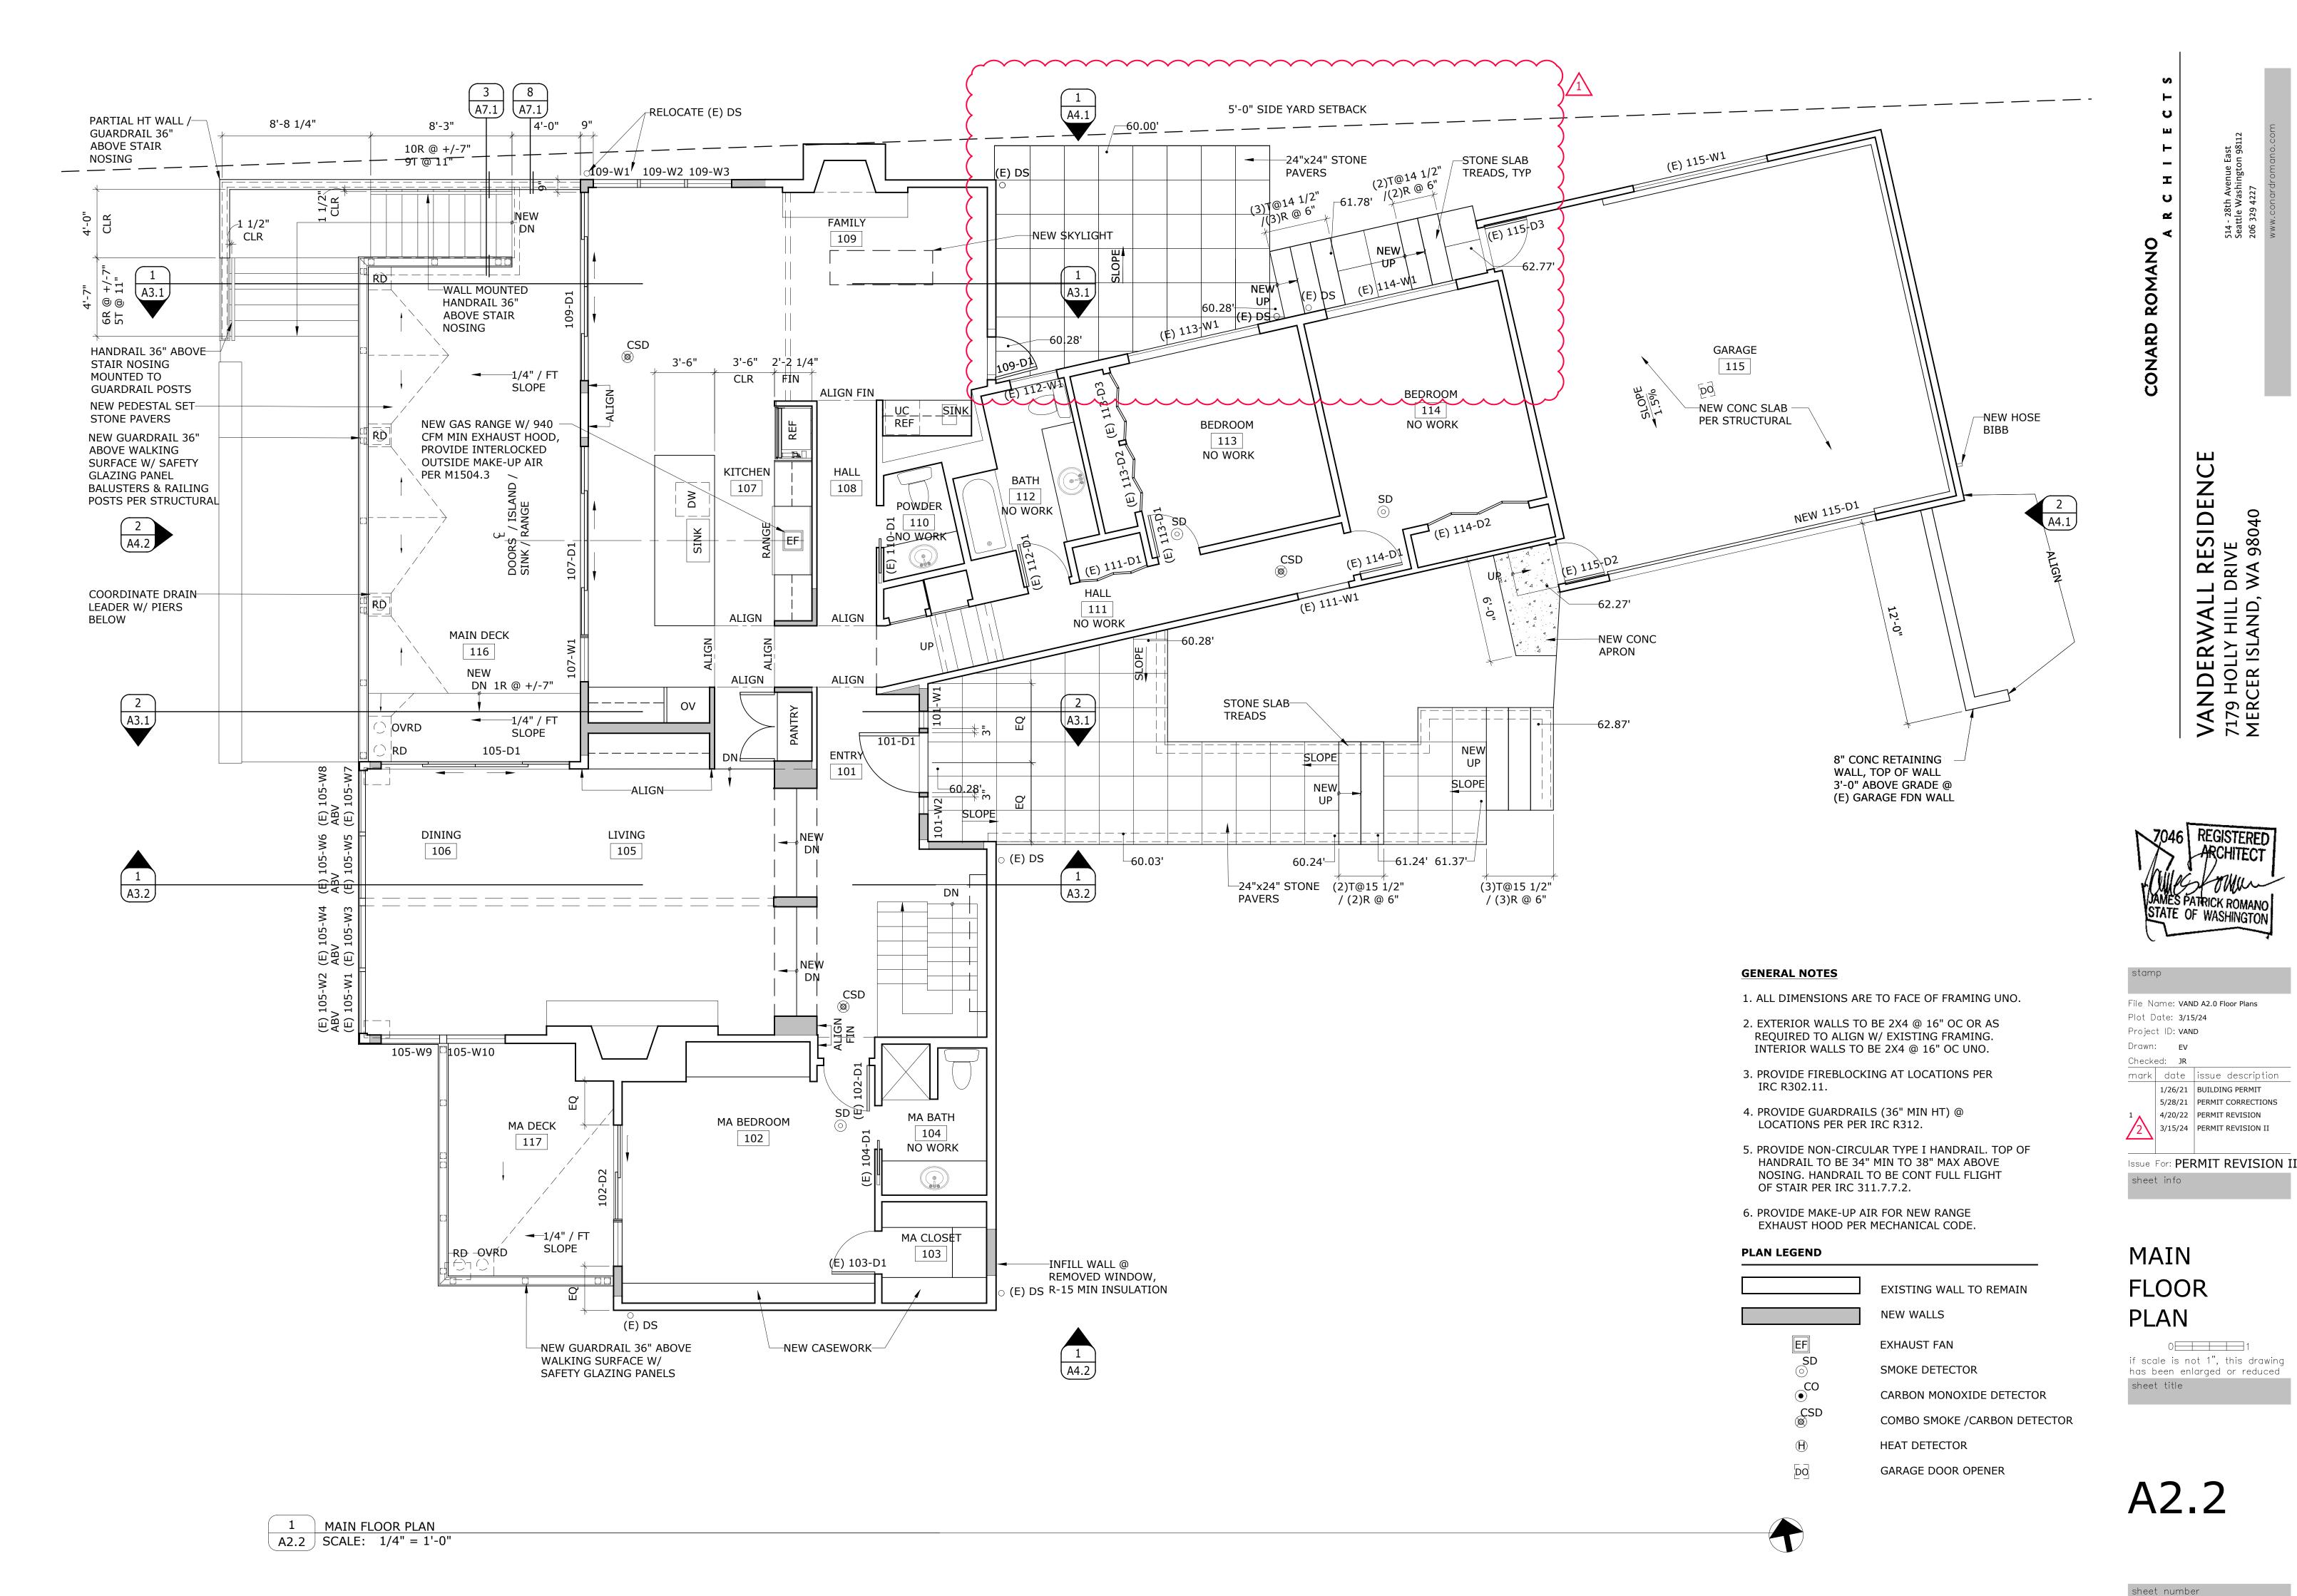

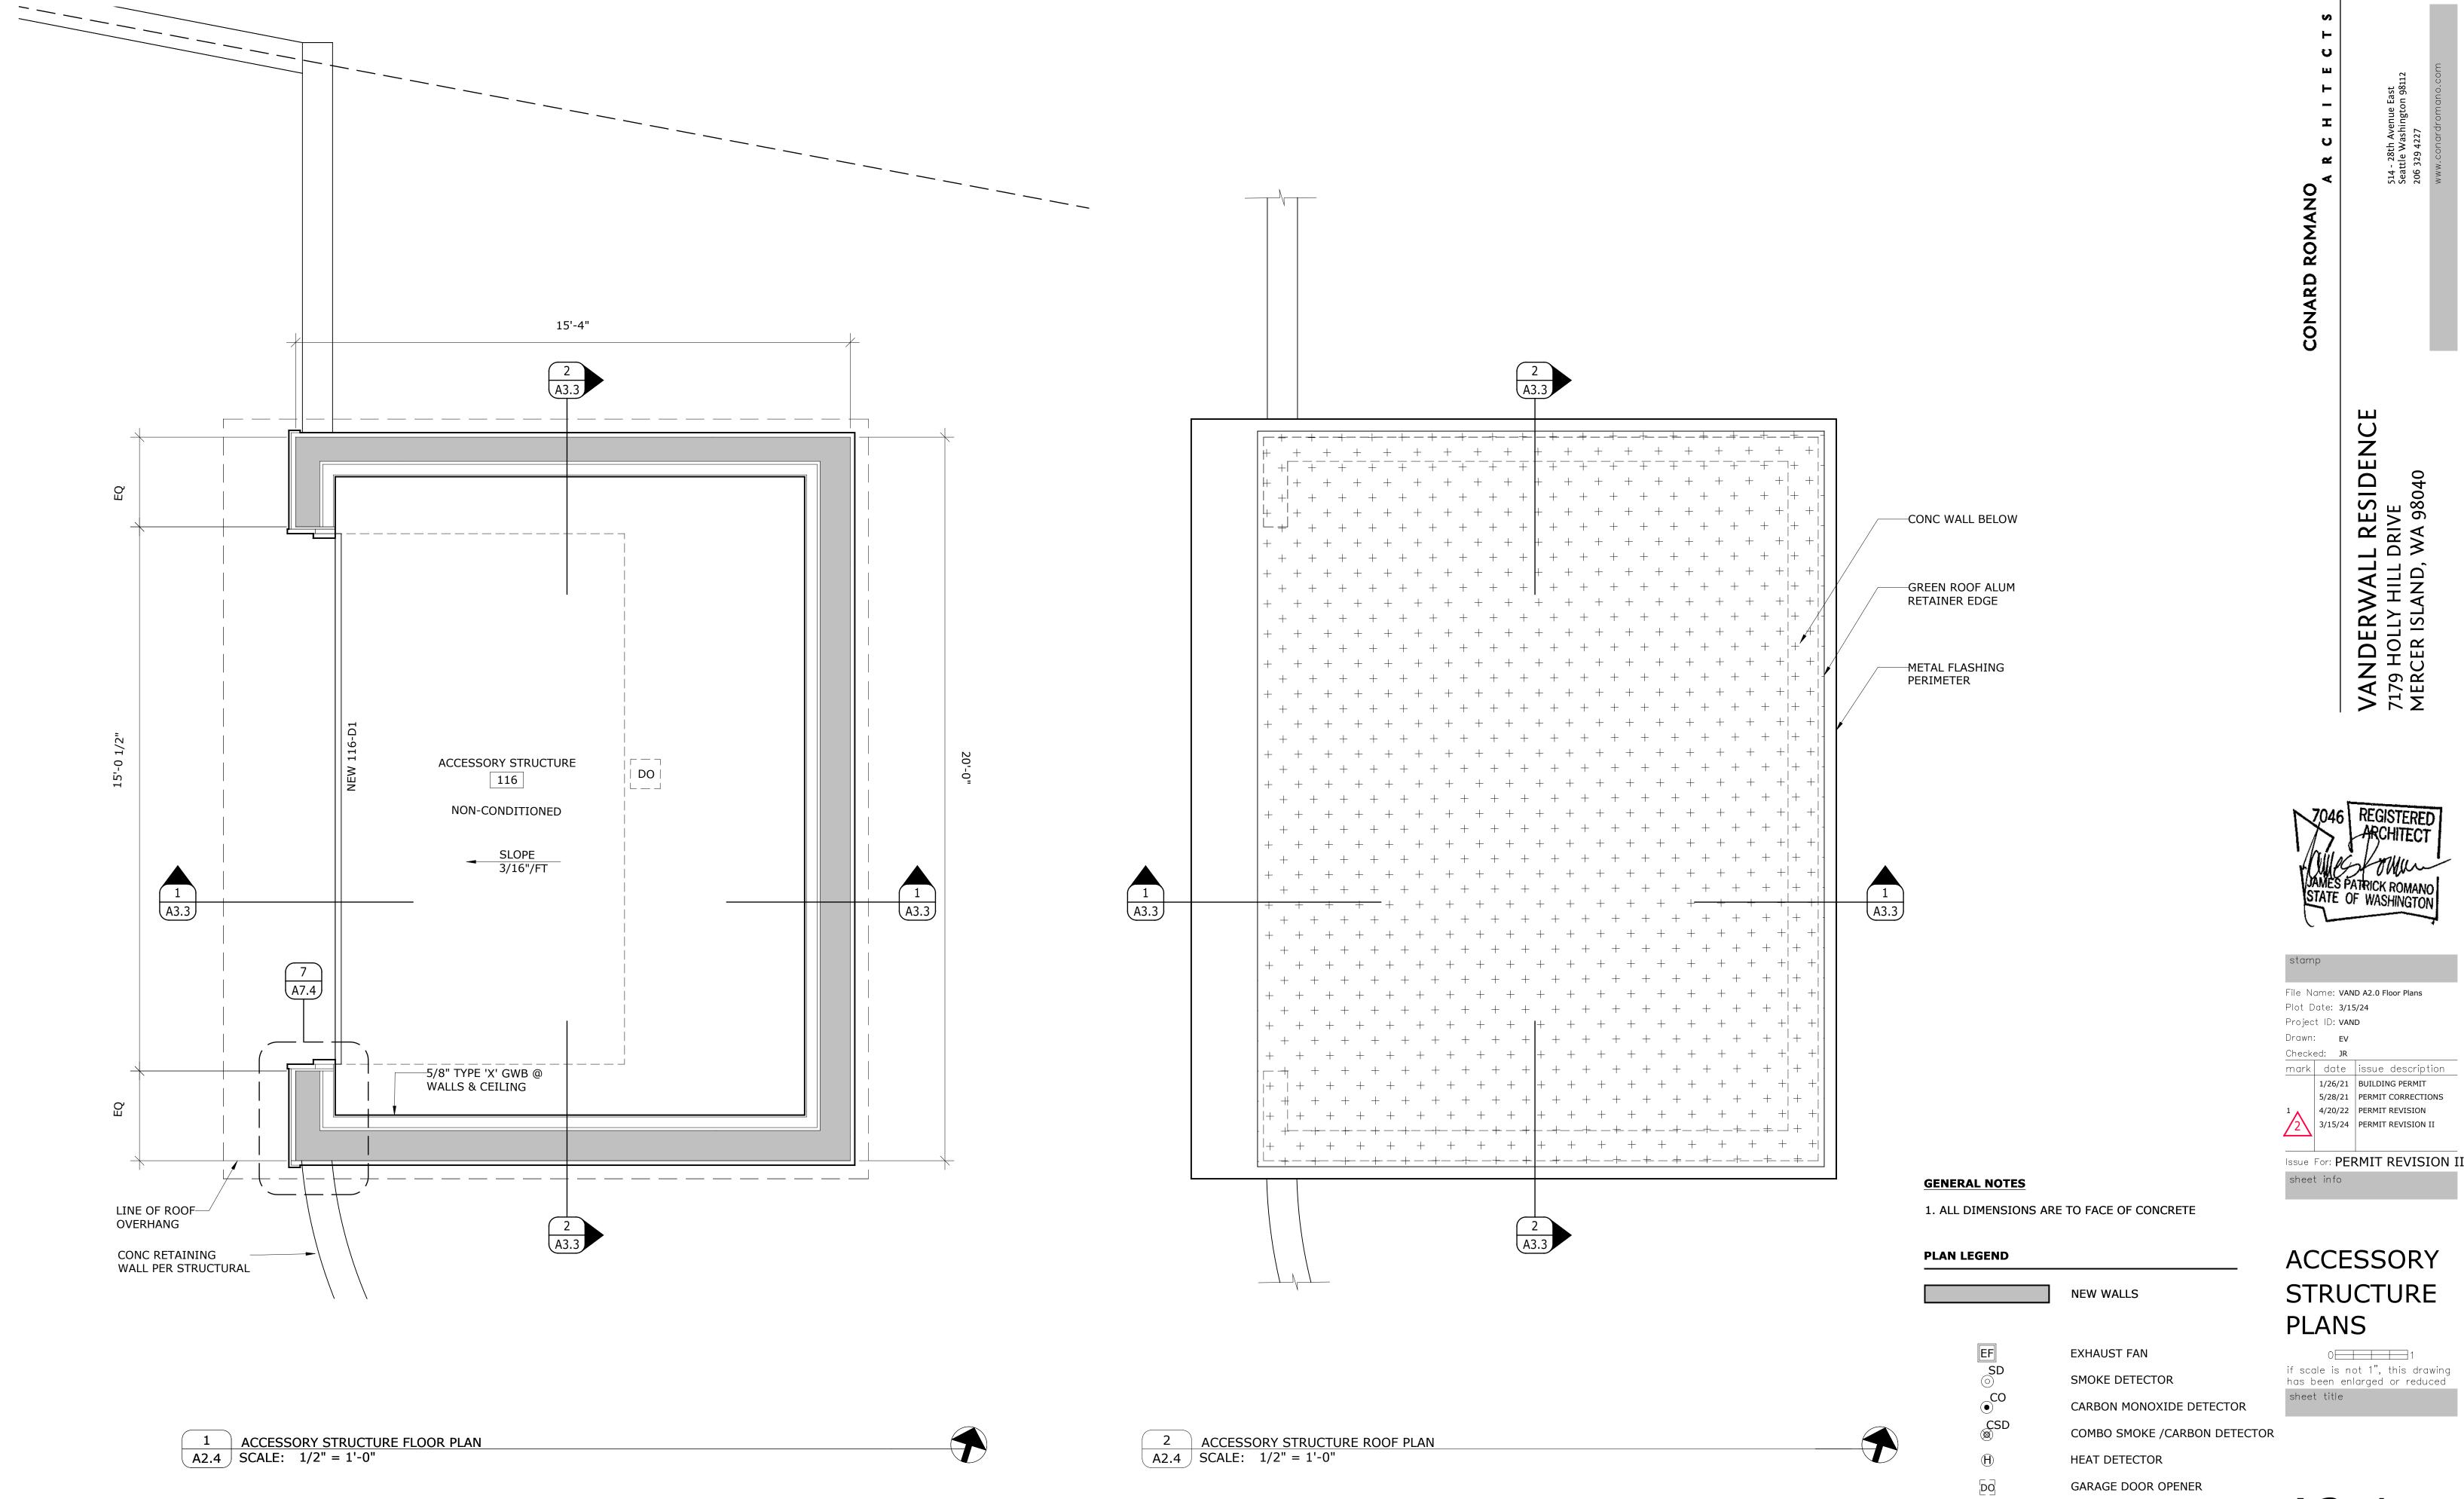

A2.4

sheet number

VANDERWALL RESIDENCE 7179 HOLLY HILL DRIVE MERCER ISLAND, WA 98040



File Name: VAND A3.0 Building Sect Plot Date: **3/15/24** Project ID: **VAND** Drawn: **EV** Checked: JR mark date issue description


3/15/24 PERMIT REVISION II Issue For: PERMIT REVISION II sheet info


BUILDING SECTION

0 1 if scale is not 1", this drawing has been enlarged or reduced sheet title

A3.3 <u>∧</u>


sheet number

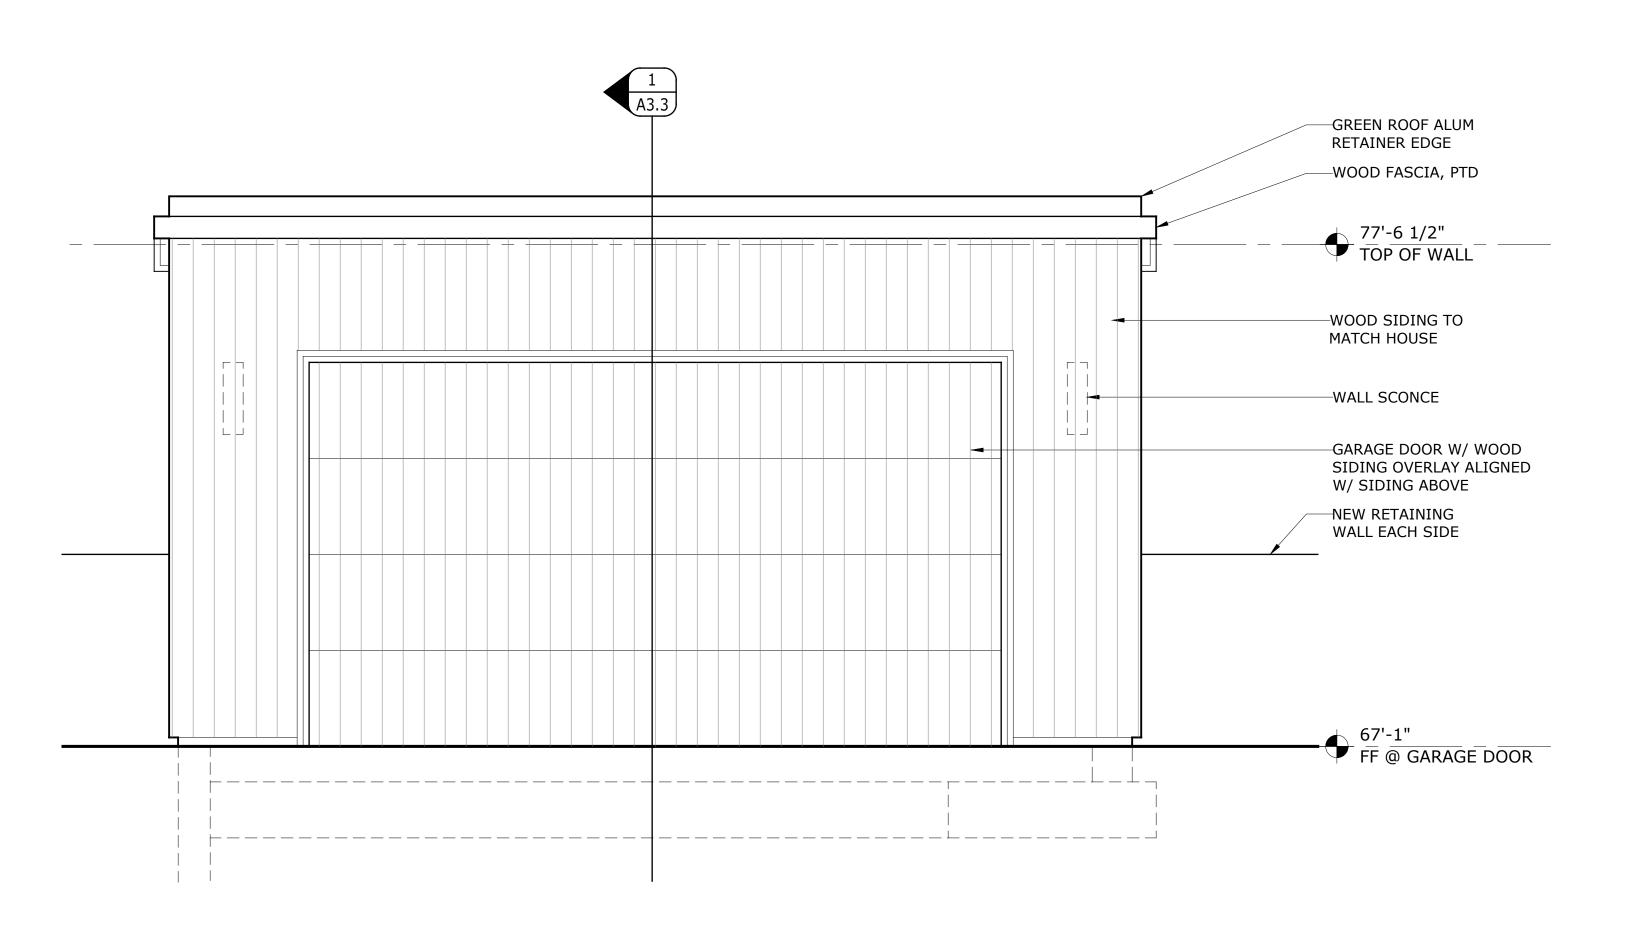


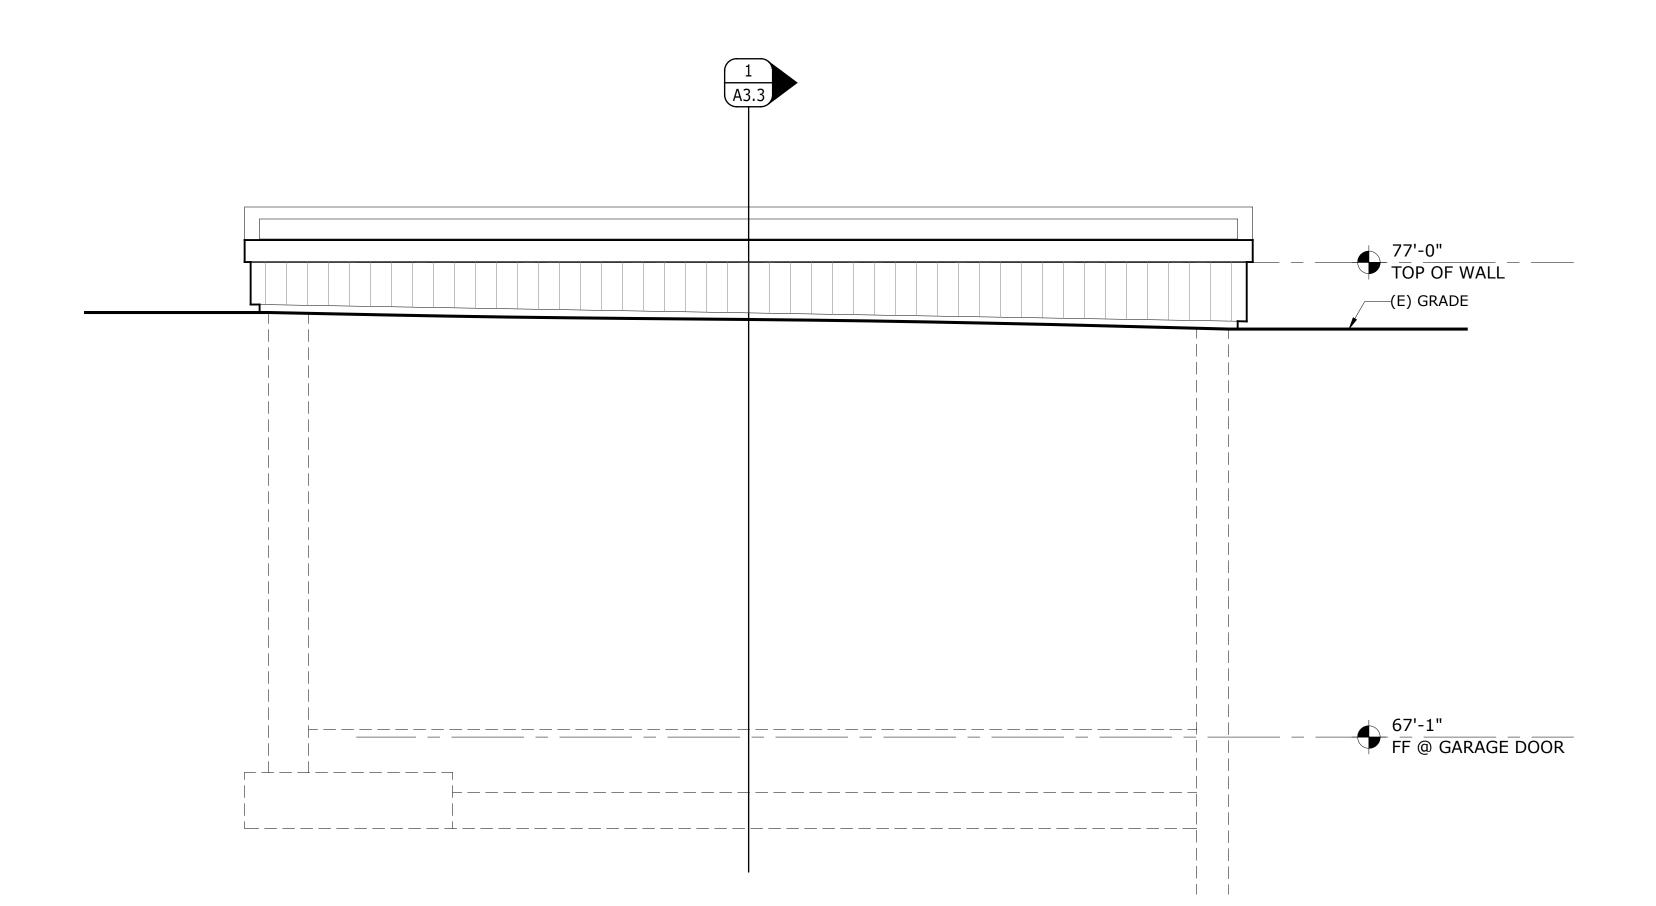

1 WEST ELEVATION
A4.3 SCALE: 1/2" = 1'-0"

3 EAST ELEVATION A4.3 SCALE: 1/2" = 1'-0"

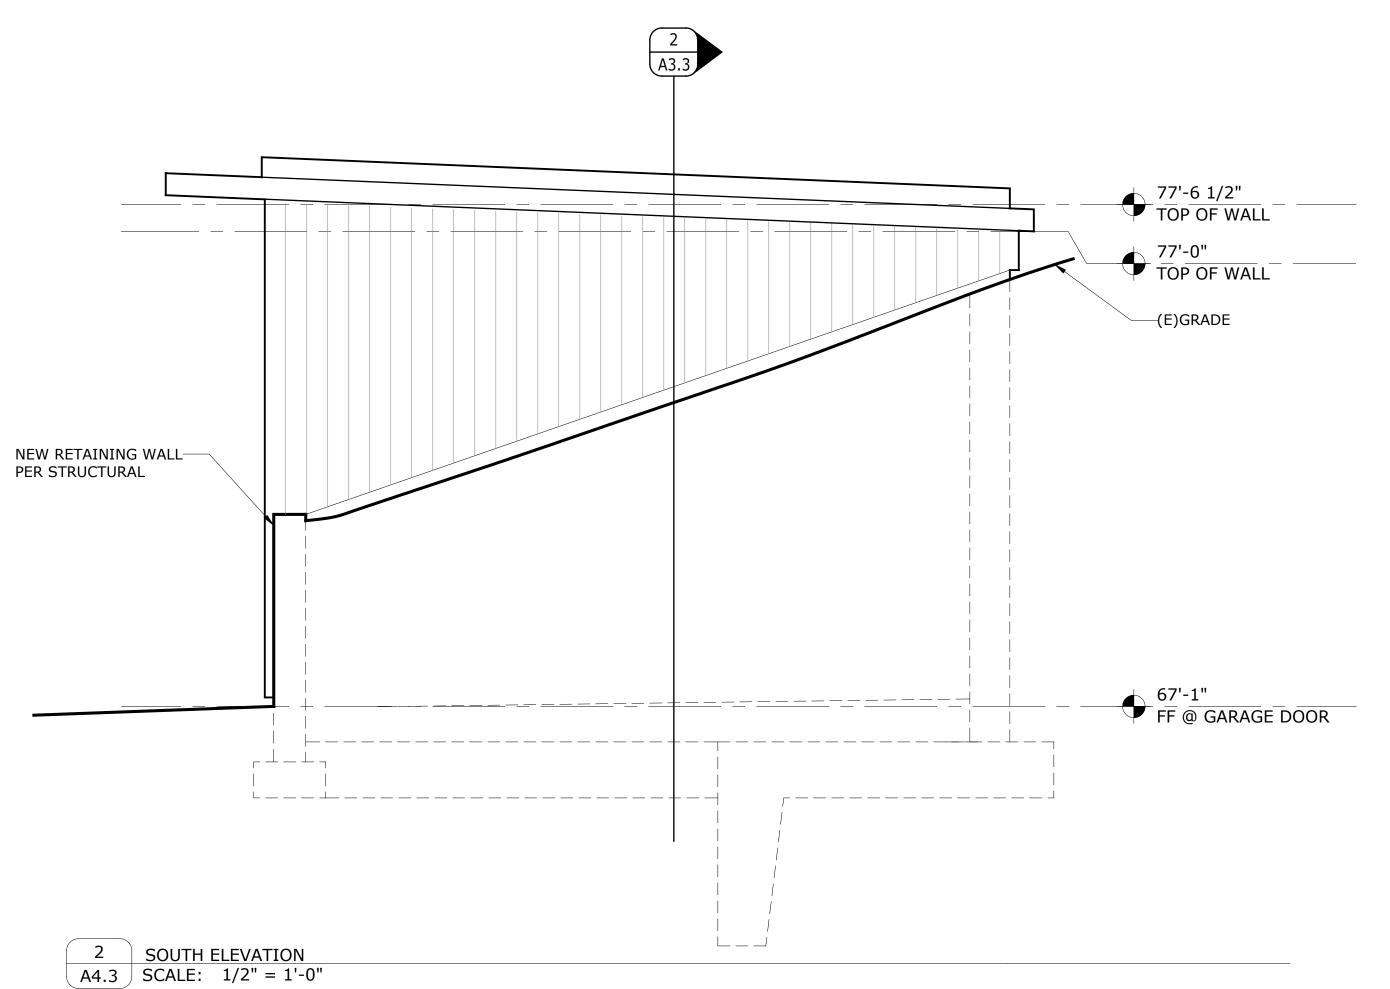

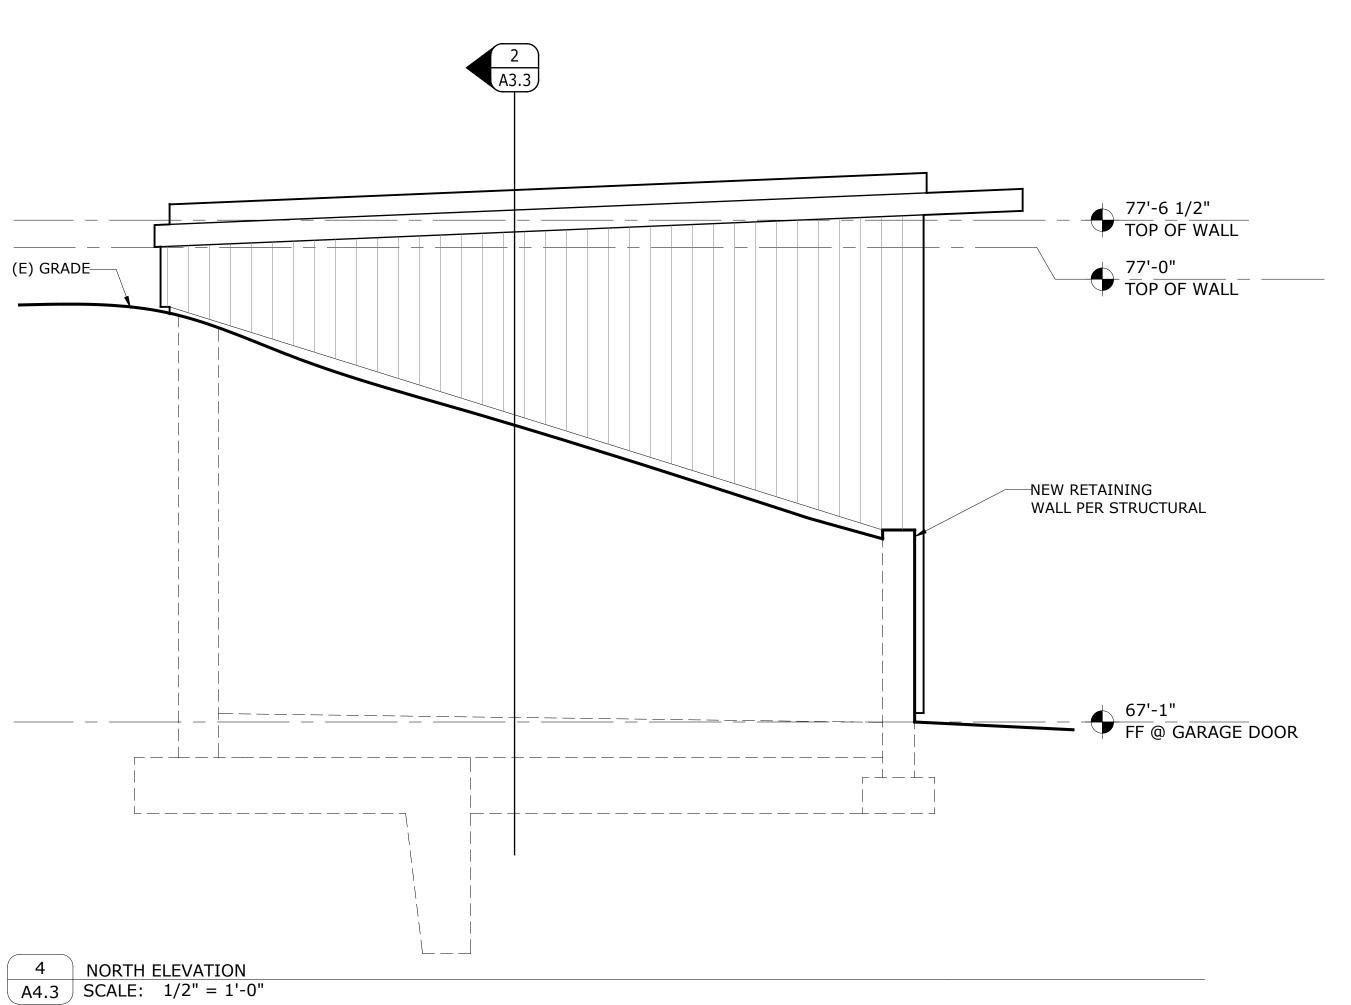

VANDERWALL RESIDENCE 7179 HOLLY HILL DRIVE MERCER ISLAND, WA 98040



Plot Date: **3/15/24** Project ID: **VAND** mark date issue description 1/26/21 BUILDING PERMIT
3/15/24 PERMIT REVISION II Issue For: PERMIT REVISION II

EXTERIOR ELEVATION


sheet info

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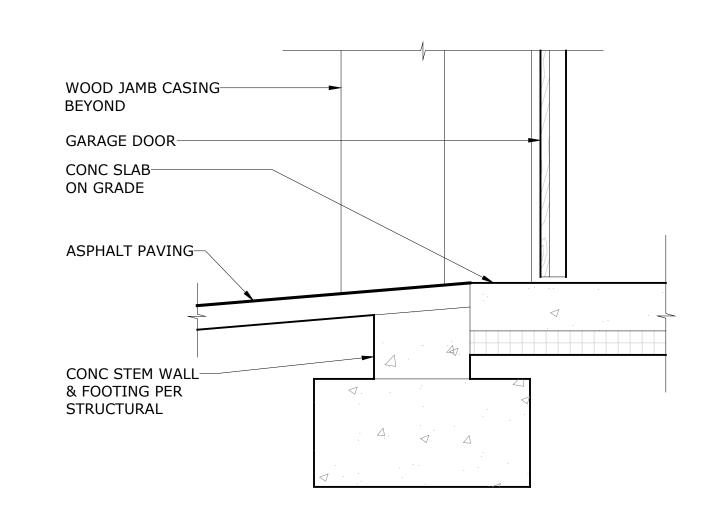
A4.3

sheet number






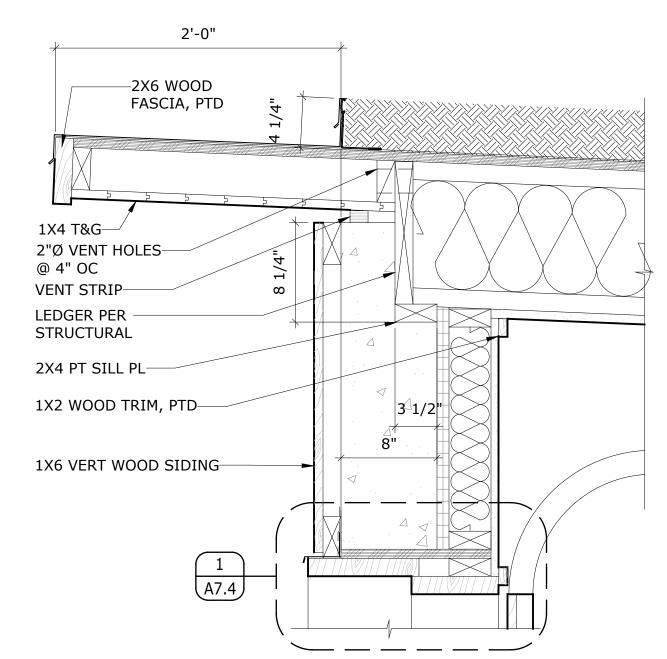




6 GARAGE DOOR SILL DETAIL
A7.4 1 1/2" = 1'-0"

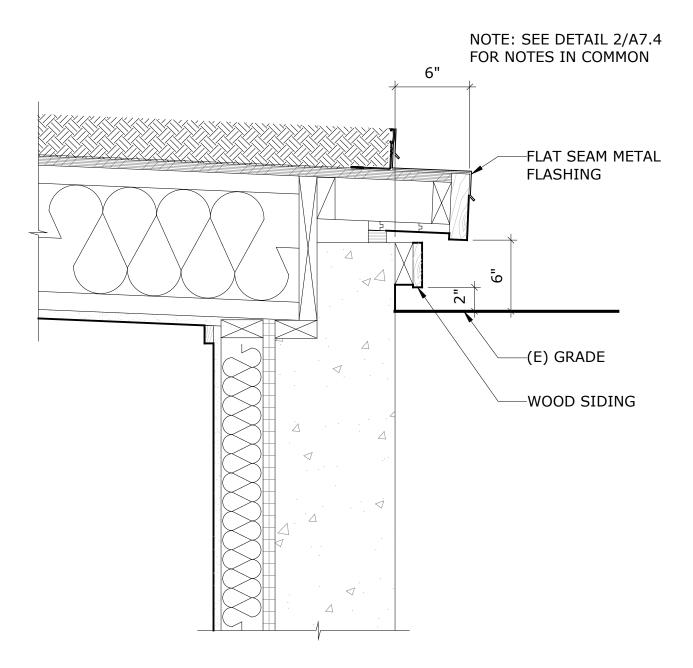

3 ROOF EAVE DETAIL A7.4 1 1/2" = 1'-0"

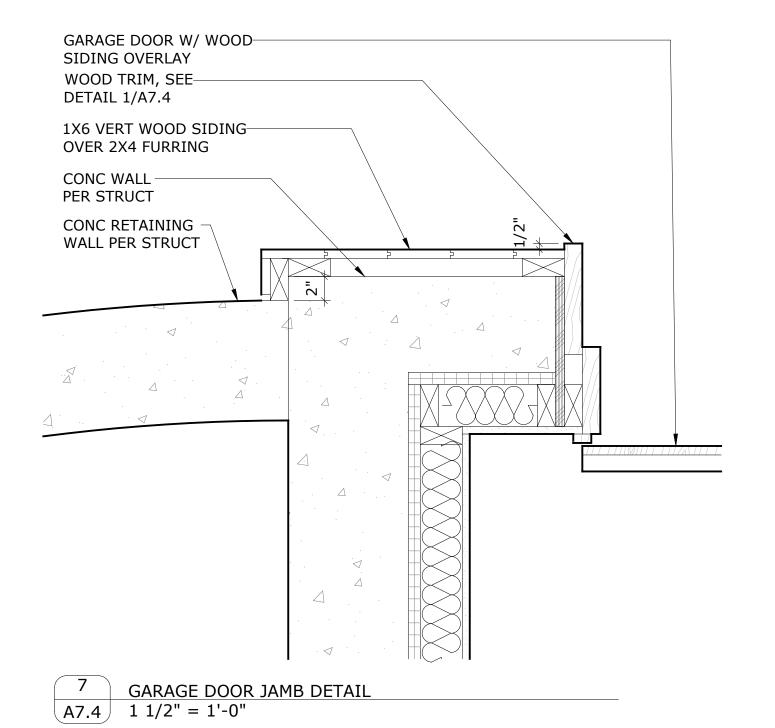


GRREN ROOF ALUM
RETAINER EDGE

2X6 FASCIA
PTD

CONC FDN WALL
PER STRUCT

1X6 VERT
WOOD SIDING

4 ROOF RAKE DETAIL
A7.4 1 1/2" = 1'-0"

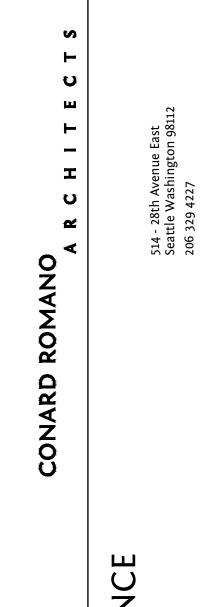

VANDERWALL RESIDENCE 7179 HOLLY HILL DRIVE MERCER ISLAND, WA 98040



File Name: VAND A7.0 EXT DETAILS
Plot Date: 3/15/24
Project ID: VAND
Drawn: EV
Checked: JR
mark date issue description

1 3/15/24 PERMIT REVISION II

Issue For: PERMIT REVISION II

EXTERIOR DETAILS

o 1 if scale is not 1", this drawing has been enlarged or reduced sheet title

A7.4 ^

C.L. PO4 PARALLEL ACCESSORY STRUCTURE PIVOT C.L. PILES P05-P07 TO AVOID BURIED UTILITIES (2) EQUAL SPACES (2) EQUAL SPACES 4'-0" 6'-0" MAX 6'-0" MAX MAX ALL DIMENSIONS ----ALONG FACE OF SHORING P06-W10x54 P03-W10x54 P04-W10x54 P05-W10x54 P07-W10x54 P01-W10x54 P02-W10x54 --<u>EL</u>--77<u>'-</u>0"-LINE OF GRADE — EL 75'-6" BEHIND LAGGING EXISTING — RETAINING EL 73'-0" BOTTOM OF EXCAVATION — EL. 65'-0" AS REQ'D FOR DRAINAGE FOR DRAINAGE PLACEMENT PLACEMENT EL 56'-0" | L| | EL 50'-0"

2 TEMPORARY SHORING ELEVATION (LOOKING NORTH)
S2.4 scale: 1/4" = 1'-0"

SHORING AND GRADING NOTES

1. EXISTING GRADES BASED ON SURVEY BY OTHERS.

2. SEE 10/S3.4 FOR GENERAL NOTES AND DESIGN

3. ALL GRADING MUST BE STABILIZED BY OCTOBER

4. TEMPORARY GRADING SLOPE SHALL NOT EXCEED 1.0 VERTICAL MAXIMMUM TO 1.0 HORIZONTAL


31. NO EXCAVATION OR FILL PLACEMENT CAN BE PERFORMED BETWEEN OCTOBER 31 AND APRIL 1.


PRESSURE DIAGRAMS FOR SHORING.

WITH ARCHITECTURAL PLANS.


MINIMUM.


FIELD VERIFY ALL ELEVATIONS AND COORDINATE

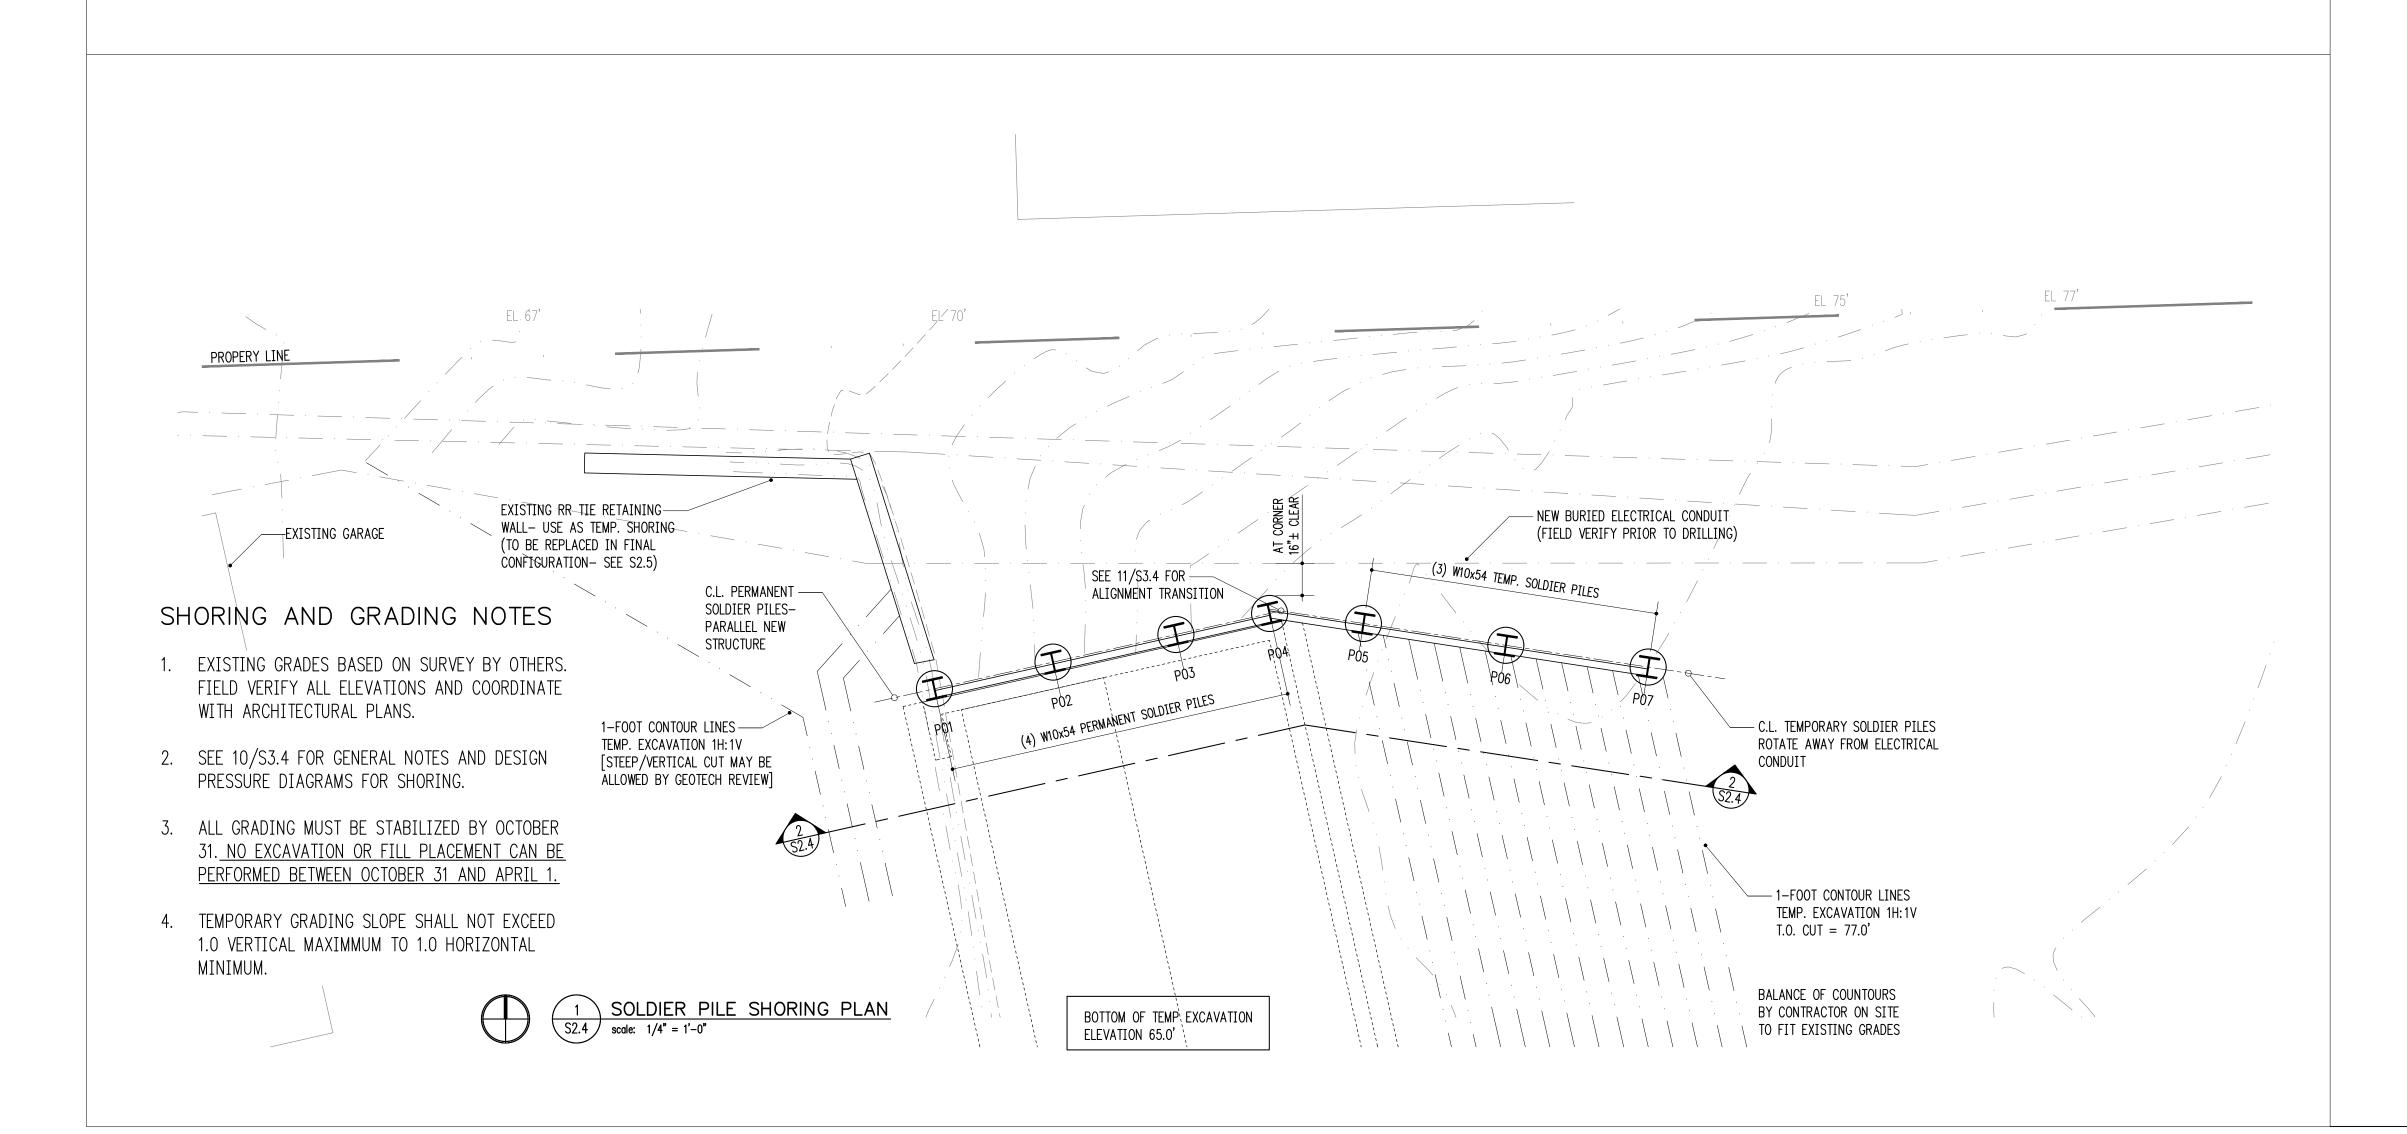


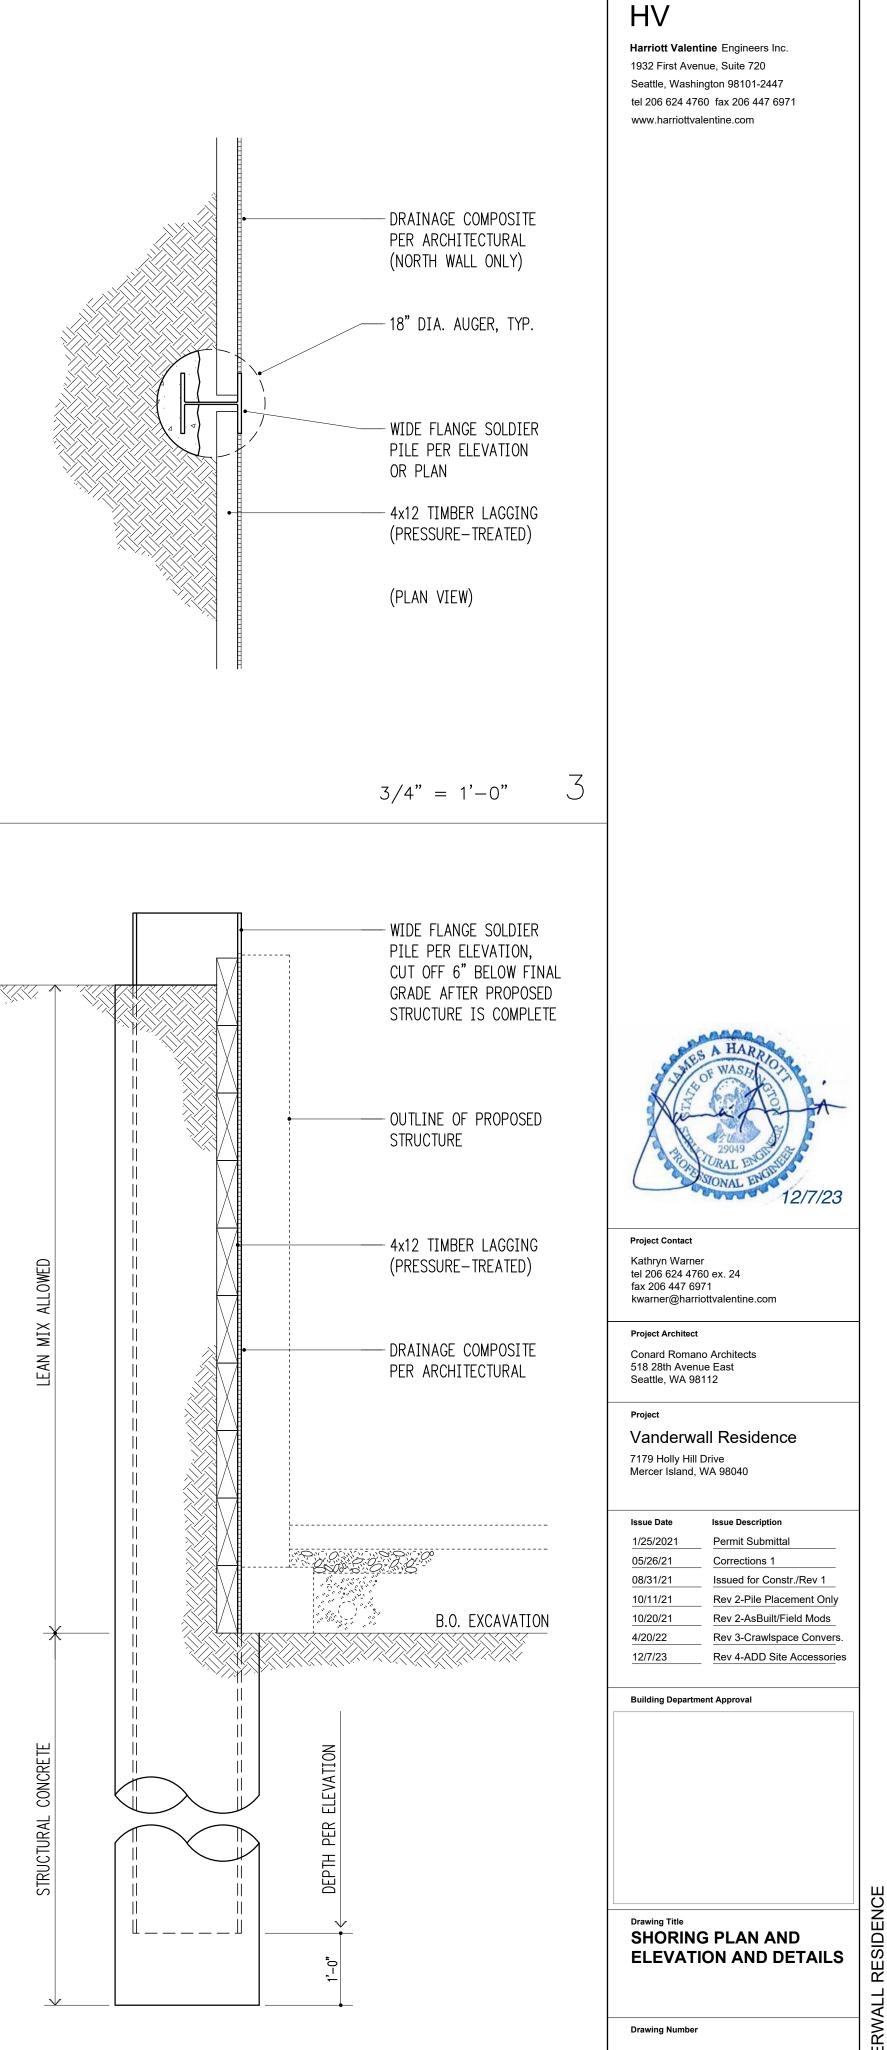



3/4" = 1'-0"

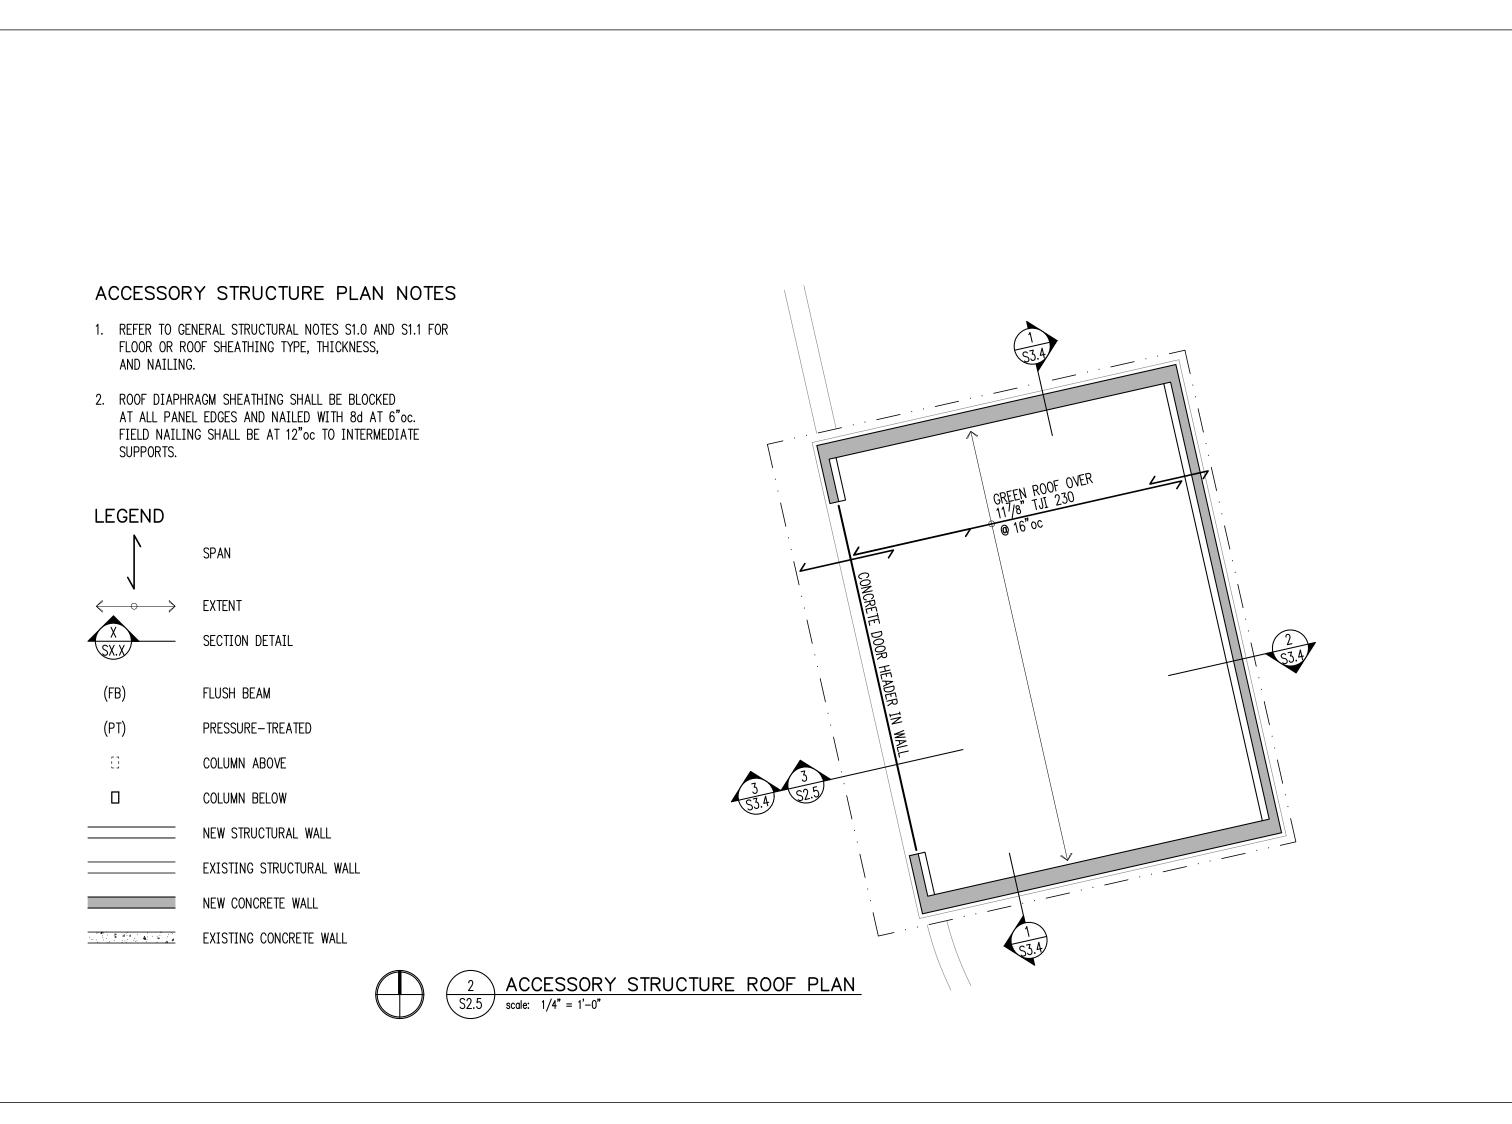


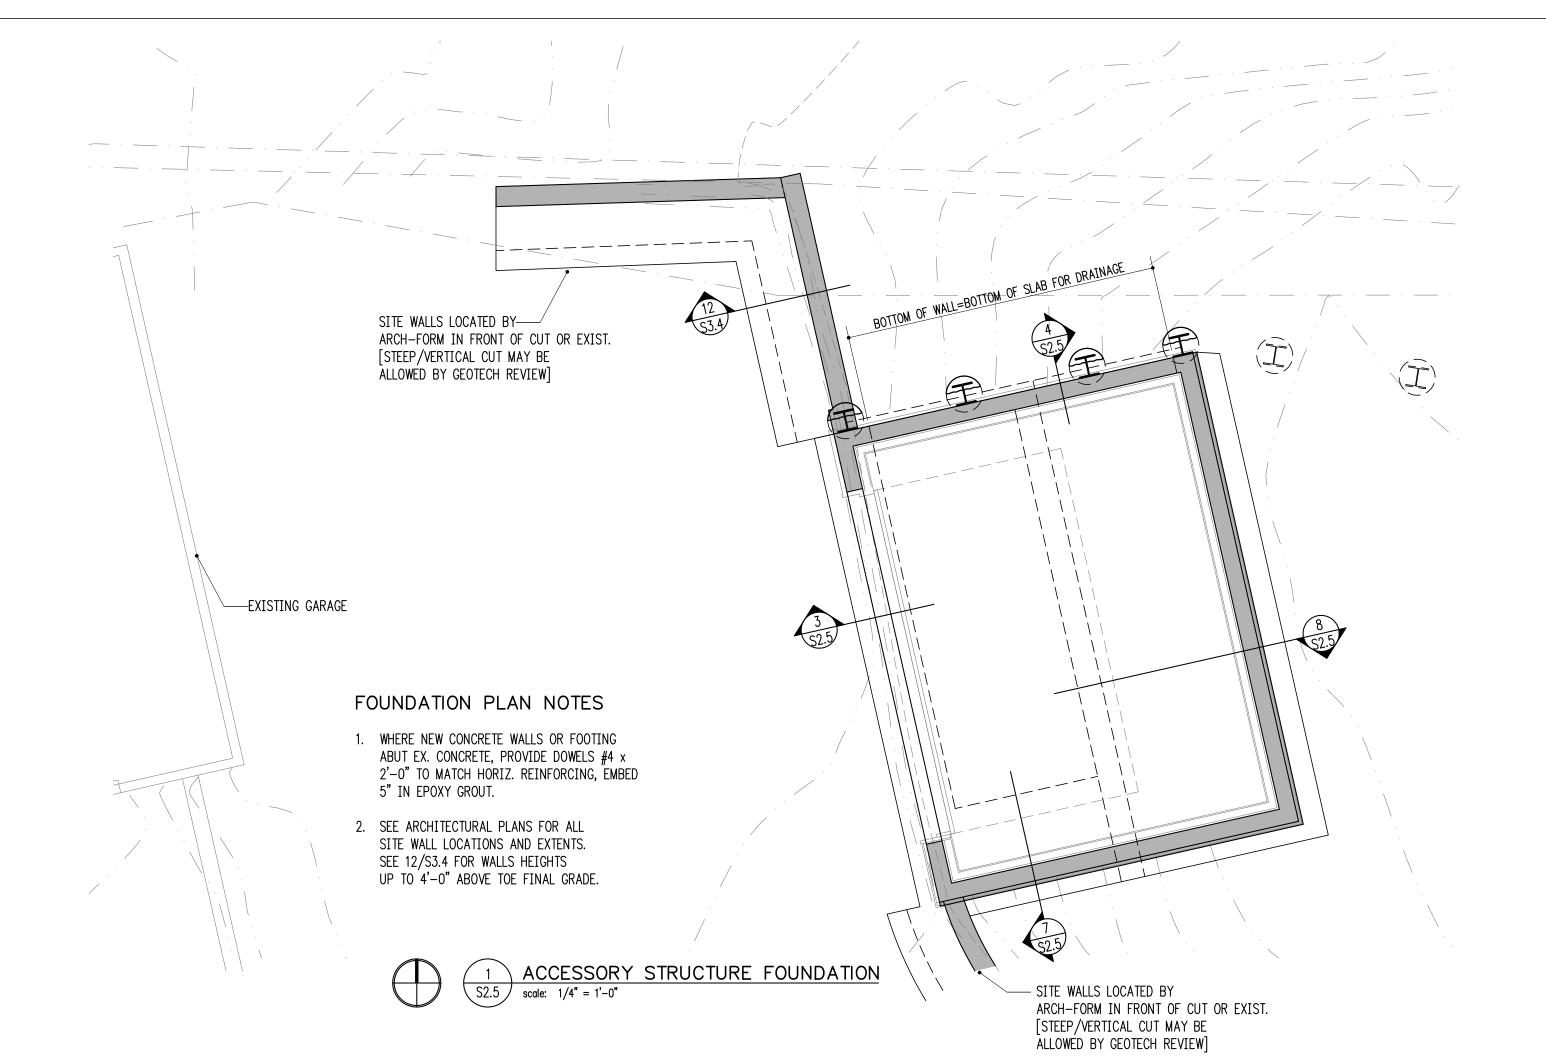


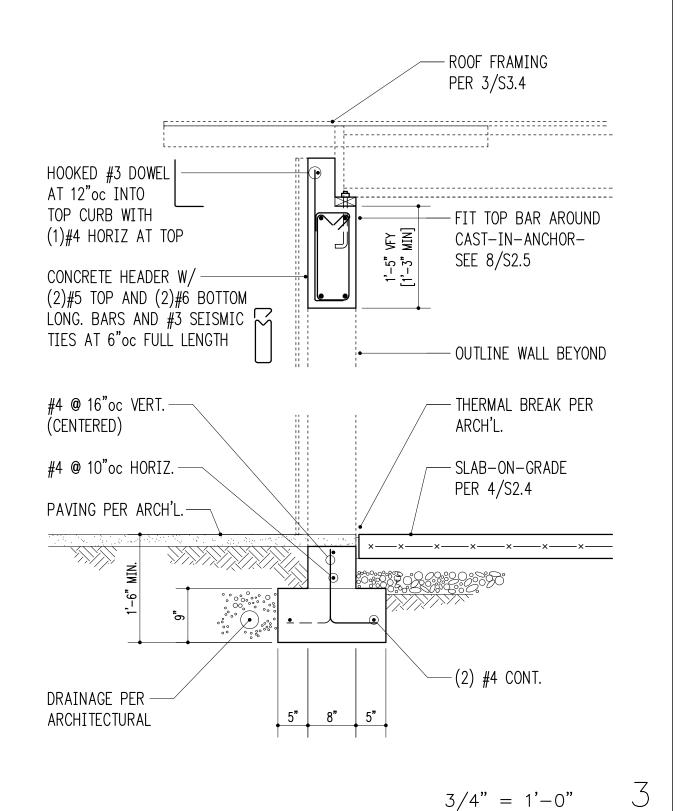

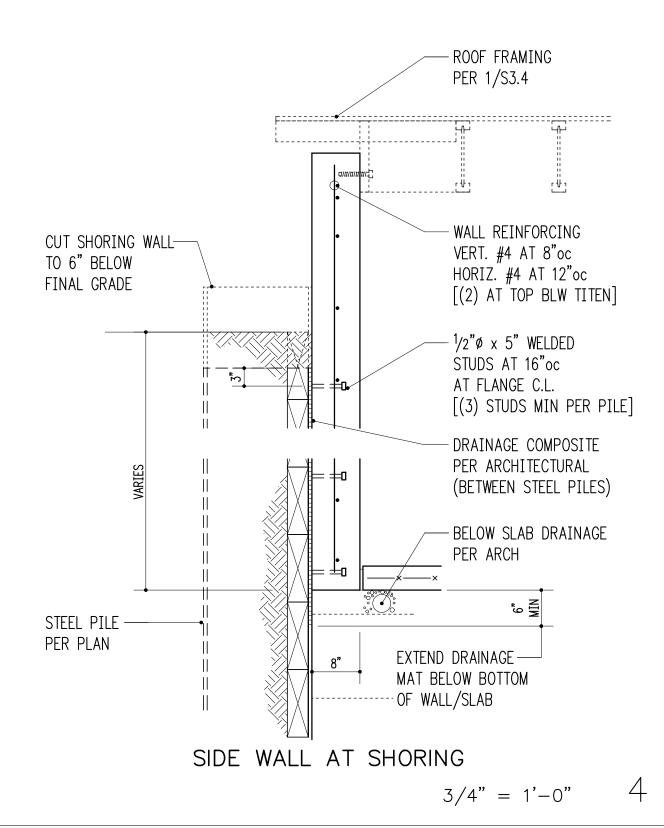

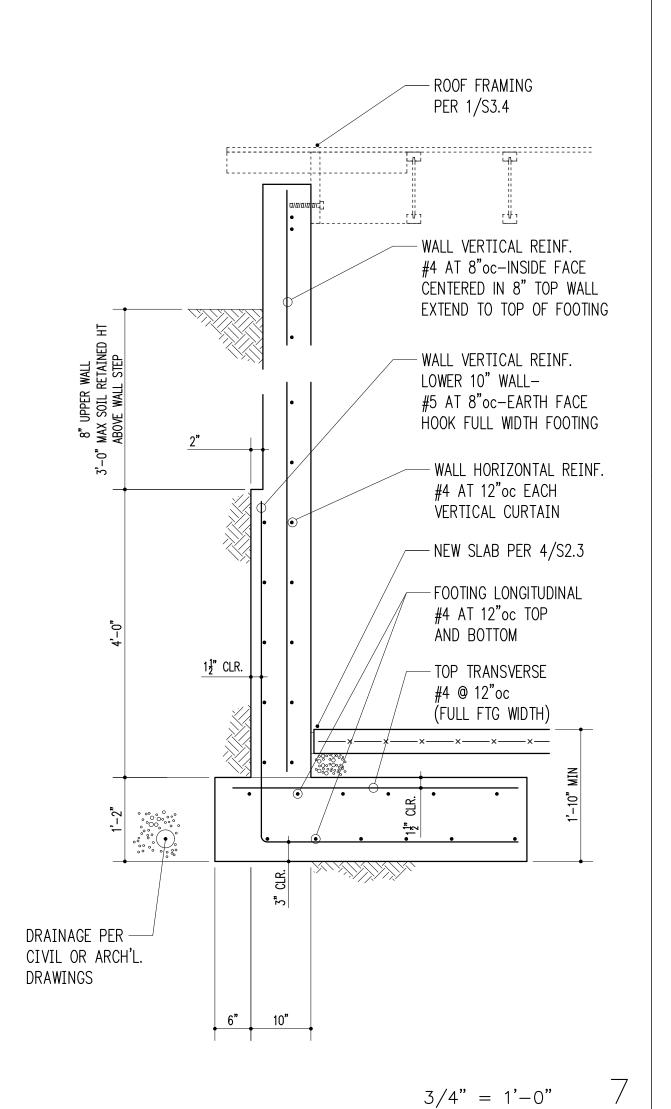

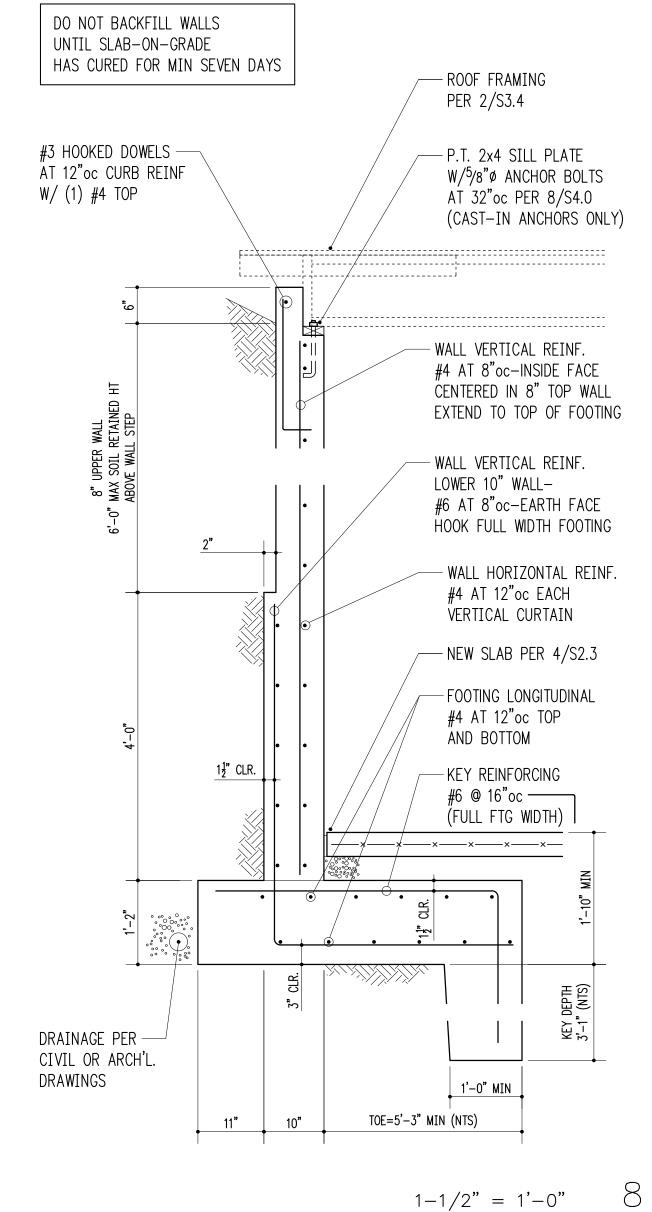

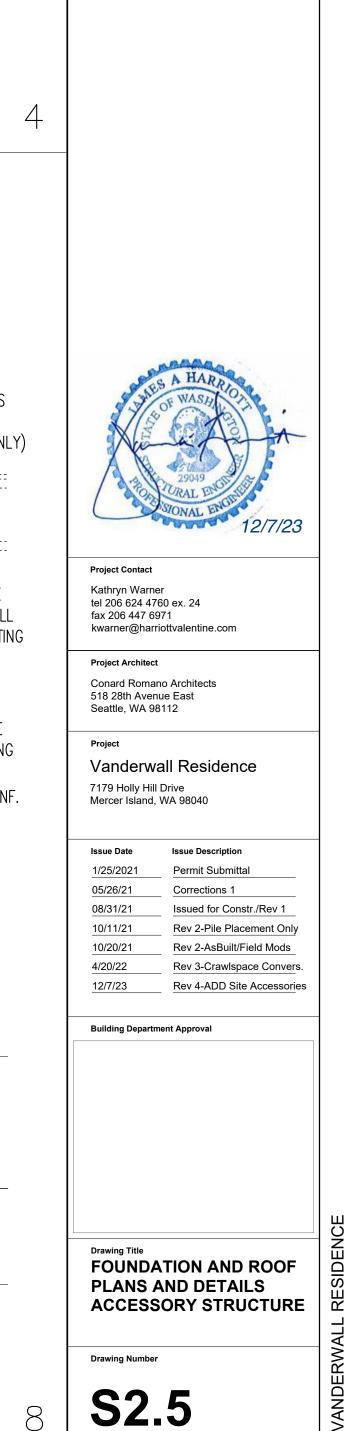


HV

Harriott Valentine Engineers Inc.

Seattle, Washington 98101-2447 tel 206 624 4760 fax 206 447 6971 www.harriottvalentine.com

1932 First Avenue, Suite 720

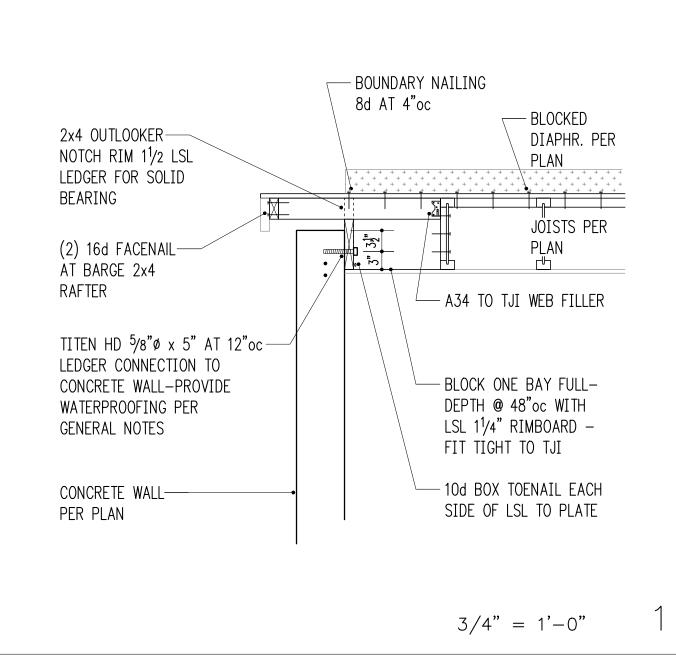

GENERAL SHORING NOTES

TEMPORARY EXCAVATION SHORING CRITERIA

WITH ARCHITECTURAL UPDATES.

APPROVED TESTING LAB.

LAGGING, AND DRAINAGE.

SHOWN ON THE PLANS MAY BE NOT COMPLETE.

(THE FOLLOWING APPLY UNLESS SHOWN OTHERWISE ON THE PLANS)

1. REFER TO THE FOLLOWING DOCUMENTS FOR ADDITIONAL INFORMATION:

B. SOILS REPORT REFERENCE: GEOTECH CONSULTANTS, INC.:

ORIGINAL ENGINEERING STUDY, DATED NOVEMBER 17, 2020.

WAS USED FOR DESIGN, IN ADDITION TO THE DEAD AND LIVE LOADS.

3. SPECIAL INSPECTION BY THE SOILS ENGINEER SHALL BE PERFORMED FOR PILE

4. THE SHORING CONTRACTOR SHALL DETERMINE THE LOCATION OF ALL ADJACENT

5. REFER TO THE SOILS REPORT FOR ADDITIONAL REQUIREMENTS, INCLUDING

UNDERGROUND UTILITIES PRIOR TO DRILLING PILE HOLES, TIEBACK ANCHORS,

OR CUTTING OR DIGGING IN STREETS OR ALLEYS. THE UTILITIES INFORMATION

RECOMMENDATIONS FOR SHORING IN GENERAL, SHORING MONITORING, EXCAVATION,

PLACEMENT (AND TIEBACK PLACING AND STRESSING, WHERE APPLICABLE). ALL

PREPARED SOIL BEARING SURFACES SHALL BE INSPECTED BY THE SOILS ENGINEER


PRIOR TO PLACEMENT OF PILE. SOIL COMPACTION SHALL BE SUPERVISED BY AN


2. DESIGN LOADS: THE SOIL PRESSURE INDICATED ON THE SOIL PRESSURE DIAGRAM


SHORING ADDENDUM DATED NOVEMBER 16, 2023,

A. TOPOGRAPHIC AND BOUNDARY SURVEY: TJC SURVEYING, DATED AUGUST 18, 2015,

GEOTECH. ENG. REPORT AND CRITICAL AREA STUDY, DATED JULY 31, 2023.

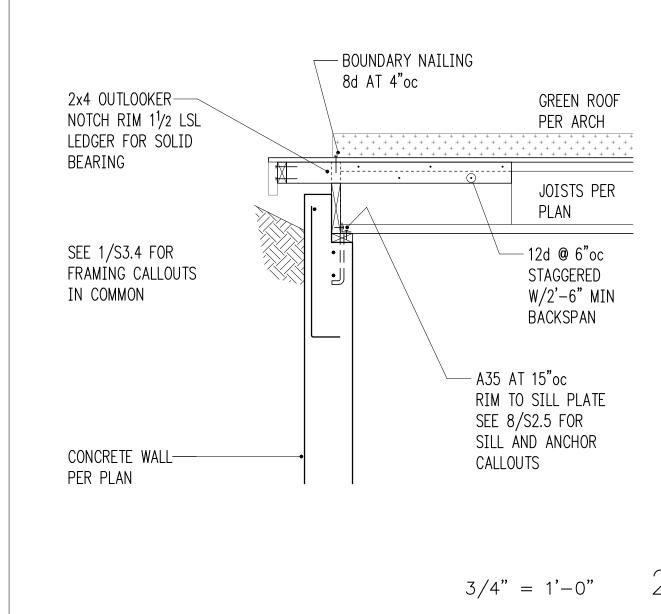

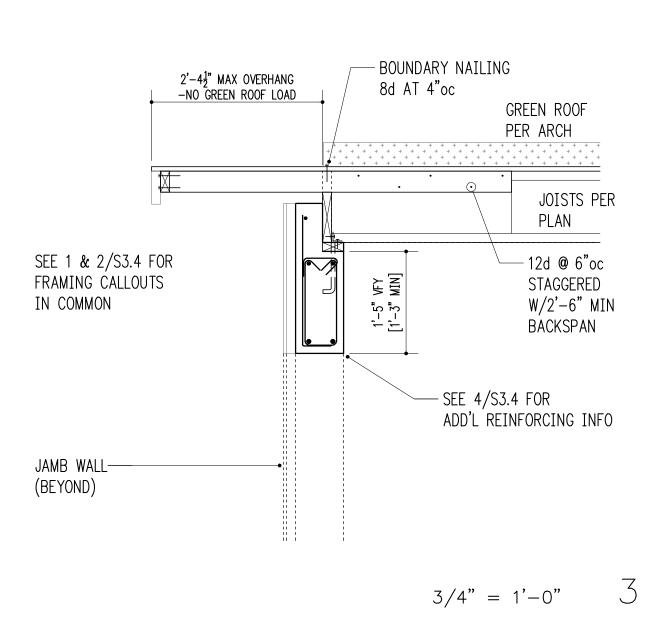

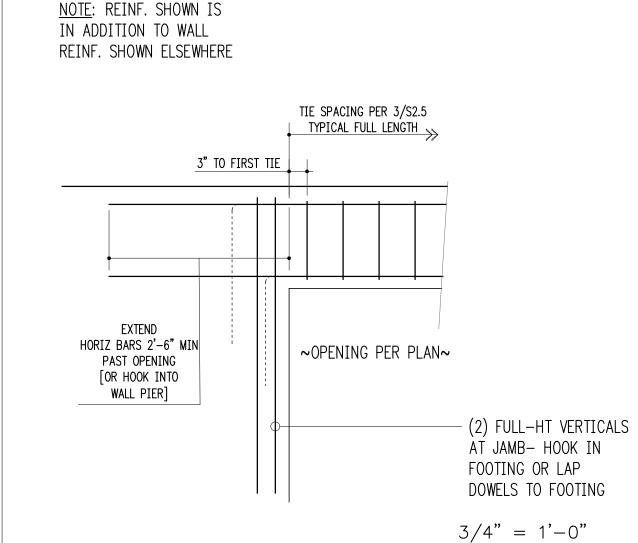

Project Contact

Kathryn Warner

fax 206 447 6971

tel 206 624 4760 ex. 24

kwarner@harriottvalentine.com

Conard Romano Architects

Vanderwall Residence

Issue Description Permit Submittal

Corrections 1

12/7/23 Rev 4-ADD Site Accessories

Issued for Constr./Rev 1

Rev 2-Pile Placement Only

Rev 2-AsBuilt/Field Mods Rev 3-Crawlspace Convers

518 28th Avenue East Seattle, WA 98112

7179 Holly Hill Drive Mercer Island, WA 98040

4/20/22


Building Department Approval

Harriott Valentine Engineers Inc 1932 First Avenue, Suite 720 Seattle, Washington 98101-2447 tel 206 624 4760 fax 206 447 6971

www.harriottvalentine.com

- CORNER BARS TO MATCH HORIZONTAL REINFORCING (ALTERNATE HOOKS) TYPICAL CORNER BARS:

- CORNER BARS TO MATCH EXT. HORIZ. REINF. = AS SHOWN DOUBLE TYPICAL CORNER BARS: CURTAIN

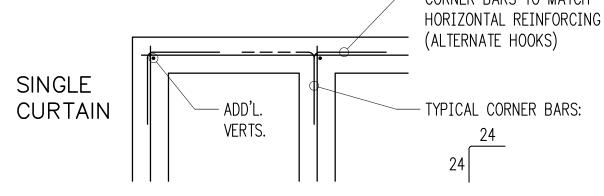

TYPICAL CORNER BARS AT CONCRETE WALLS 3/4" = 1'-0"

ARCHITECTURAL


#4 @ 10"oc HORIZ. [(2) AT TOP OF WALL]

3/4" = 1'-0"


SOLDIER PILE AND LAGGING CONSTRUCTION

- 6. PILE LEAN MIX SHALL CONTAIN 1-1/2 SACKS OF CEMENT PER CUBIC YARD. THERE IS NO STRENGTH REQUIREMENT FOR THIS MIX.
- LAGGING SHALL CONSIST OF SAWN LUMBER AND SHALL CONFORM TO "GRADING AND DRESSING RULES," WEST COAST LUMBER INSPECTION BUREAU (WCLIB), LATEST EDITION. LAGGING SHALL BE 4X12 DOUGLAS FIR-LARCH NO. 2 OR HEM-FIR NO. 1. TIMBER LAGGING SHALL BE PRESSURE TREATED WITH WATERBORNE PRESERVATIVES IN ACCORDANCE WITH AWPB LP-22 TO A MINIMUM RETENTION OF 0.4 LBS/CU.FT. LAGGING SHALL BE 4X12 UNLESS OTHERWISE NOTED ON DRAWINGS.
- DEMOLITION: SHORING AND SOIL EXCAVATION SHALL BE DONE SIMULTANEOUSLY.
- VERIFICATION: DIMENSIONS AND LOCATION OF EXISTING STRUCTURES SHALL BE VERIFIED PRIOR TO FABRICATION AND INSTALLATION OF ANY STRUCTURAL MEMBER. NOTIFY ENGINEER ABOUT ANY DISCREPANCIES PRIOR TO FABRICATION.
- 10. HOLE DIGGING: PILE AND ANCHOR HOLES SHALL BE DRILLED WITHOUT LOSS OF GROUND AND WITHOUT ENDANGERING PREVIOUSLY INSTALLED PILES AND ANCHORS. THIS MAY INVOLVE CASING THE HOLES OR OTHER METHODS OF PROTECTION FROM CAVING. REFER TO REPORT OF GEOTECHNICAL INVESTIGATION FOR RECOMMENDED HOLE DIGGING PROCEDURE.
- 11. PILE PLACEMENT: ALTERNATE PILES SHALL BE PLACED AND COMPLETED SO THAT AT LEAST 24 HOURS IS ALLOWED FOR THE CONCRETE TO SET PRIOR TO DRILLING ADJACENT PILES.

- 12. STEEL PILE PLACEMENT TOLERANCES:
- 1" INSIDE PERPENDICULAR TO SHORING WALL. 1" OUTSIDE PERPENDICULAR TO SHORING WALL. 3" LATERALLY.
- 13. LAGGING: TIMBER LAGGING SHALL BE INSTALLED IN ALL AREAS. VOIDS BETWEEN LAGGING AND SOIL SHALL BE BACKFILLED. DRAINAGE BEHIND THE WALL MUST BE MAINTAINED. IT IS CONTRACTOR'S RESPONSIBILITY TO LIMIT THE AMOUNT OF EXPOSED SOIL WITHOUT LAGGING TO AVOID LOSS OF SOIL. MAXIMUM HEIGHT OF 4 FEET IS RECOMMENDED. SPECIAL CARE SHOULD BE TAKEN TO AVOID GROUND LOSS DURING EXCAVATION.

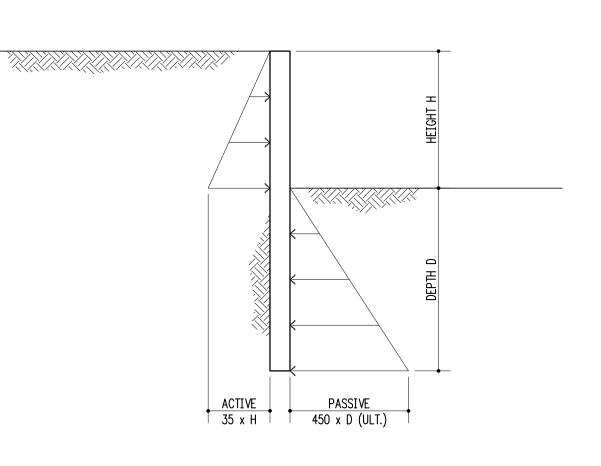


SOIL PRESSURE DIAGRAM-TEMPORARY PILES

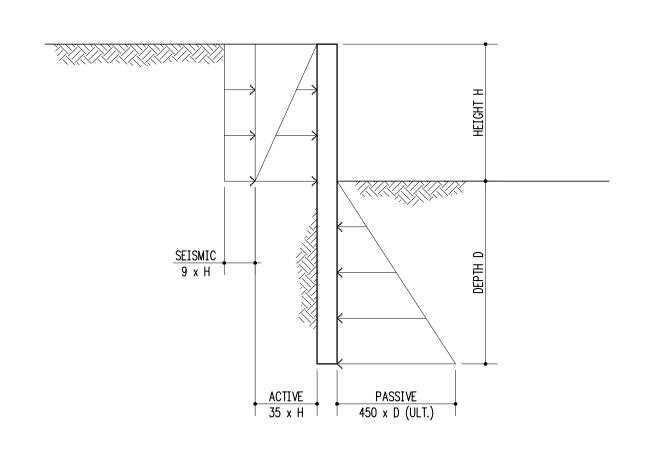

SOIL PRESSURE DIAGRAM-PERMANENT PILES

3/4" = 1'-0" 1 0

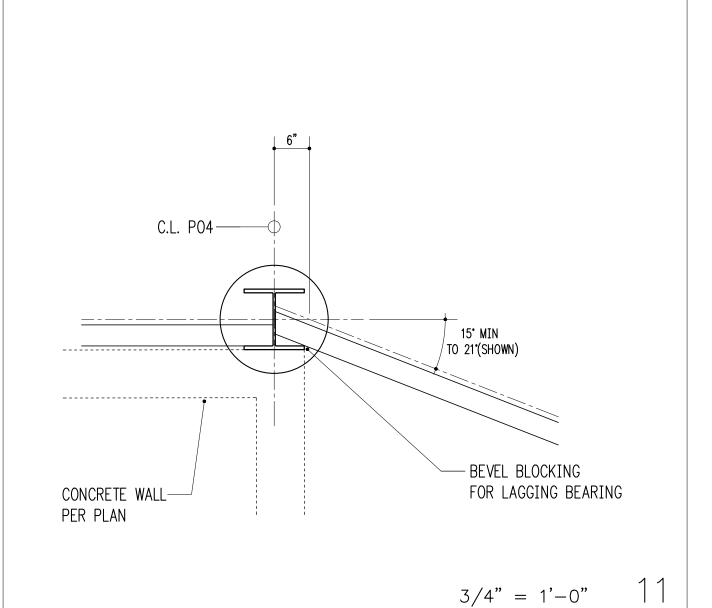

LEVEL PARKING AREA #4 @ 10"oc VERT. OR STEEP SLOPE (CENTERED) 1'-6" | W/8" COVE ૢૺ૾ઌૺૢ૾ૺૢૺૢ૽ૺૢ૾ૺઌ BACKFILL AND DRAINAGE PER 2'-8" 9" GEOTECH AND

STRUCTURAL DETAILS SITE WALLS AND ACCESSORY STRUCTURE

S3.4